

### Design Review Subcommittee (DRSC)

Meeting Date: October 23, 2024

**PLANNER:** David Carrillo, Associate Planner

SUBJECT: Pre-Application (PREAPP) 24-464, Salty Turf Mini Golf, a

request for preliminary feedback on a miniature golf course facility proposed on vacant land within Vista Hermosa Sports

Park located at 48 Avenida La Pata.

### **BACKGROUND**:

The subject site is City-owned and is 80.74 acres, located at the southwest corner of Avenida La Pata and Avenida Vista Hermosa. The site is within multiple zoning districts of the Forster Ranch Specific Plan: Open Space Public (OS1); Public (P); and Neighborhood Commercial (NC1.2). Development on-site consists of the Vista Hermosa Sports Park (VHSP) within the OS1 Zone, and Orange County Fire Authority Station No. 59 within the P Zone. The project is proposed on vacant land within VHSP (see yellow outlined area on Figure 1 below). This area is adjoining ground-mounted solar panels, Courtney's Sandcastle playground, and the Aquatics Complex. See **Attachment 1** for a location map and **Attachment 2** for a zoning map.



Figure 1 – Aerial View of Project Site

The applicant entered into a 20-year City lease on April 1, 2024 to construct and operate a miniature golf course facility with approval of zoning permits. The applicant proposes to construct one-story Spanish Colonial Revival styled structures within the center of the site plan: a clubhouse building, kitchen building, and covered outdoor dining spaces. Two miniature golf courses, labeled on plans as "Fantasy Course" and "Pro Course", are proposed on both sides of the buildings. Building features and materials consists of a symmetrical front facade, wing towers, pitched clay tile roofs, flat roofs, cornices, white stucco, curved wall edges, a wood trellis, awnings, decorative wrought iron, and decorative tiles. See **Attachment 4** for conceptual plans. A landscape plan was not submitted. However, renderings show an intent to provide landscaped areas at the front and within the project's site plan.

The purpose of this preliminary application is to get feedback to inform the preparation of materials to apply for a Development Permit and Conditional Use Permit. The project would be subject to the <a href="City's General Design Guidelines">City's General Design Guidelines</a> and <a href="Henry Lenny Design Guidelines">Henry Lenny Design Guidelines</a>. The General Plan requires new public buildings to have Spanish Colonial Revival architecture. For preliminary applications, applicants have the option to review their conceptual plans with the Development Management Team (DMT) and Design Review Subcommittee (DRSC). This is the purpose of this agenda item. The Development Management Team (DMT) is reviewing the project, and has not provided preliminary comments yet. The applicant agreed to concurrent review by the DMT and DRSC to streamline the formal submittal after preliminary review.

### **RECOMMENDATIONS:**


Staff's position is that the project is conceptually consistent with design guidelines. Staff recommends that the applicant include the following for a zoning permit application: landscaping, building and site signage, lighting, building equipment (roof-and ground-mounted), and analyses on the project's consistency with General Plan policies and design guidelines. See **Attachment 3** for a list of relevant General Plan Policies and design guidelines.

The applicant and staff seek the DRSC's preliminary feedback on the conceptual project plans, in terms of their consistency with design guidelines. The applicant will use the provided feedback to refine plans and materials for an application to seek approval of a Development Permit and Conditional Use Permit to allow the proposed project. The project will be reconsidered by the DRSC when the application is processed.

### Attachments:


- 1. Site Location Map
- 2. Forster Ranch Specific Plan Master Land Use Plan
- 3. Relevant General Plan Goals / Policies
- 4. Conceptual Plans



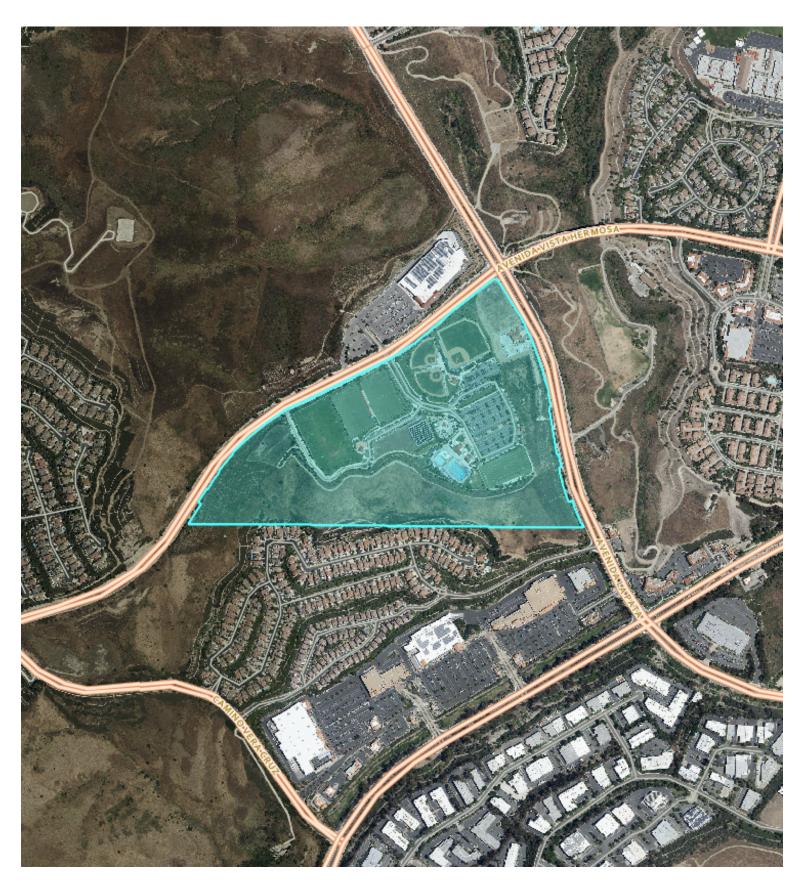



### **ATTACHMENT 2**

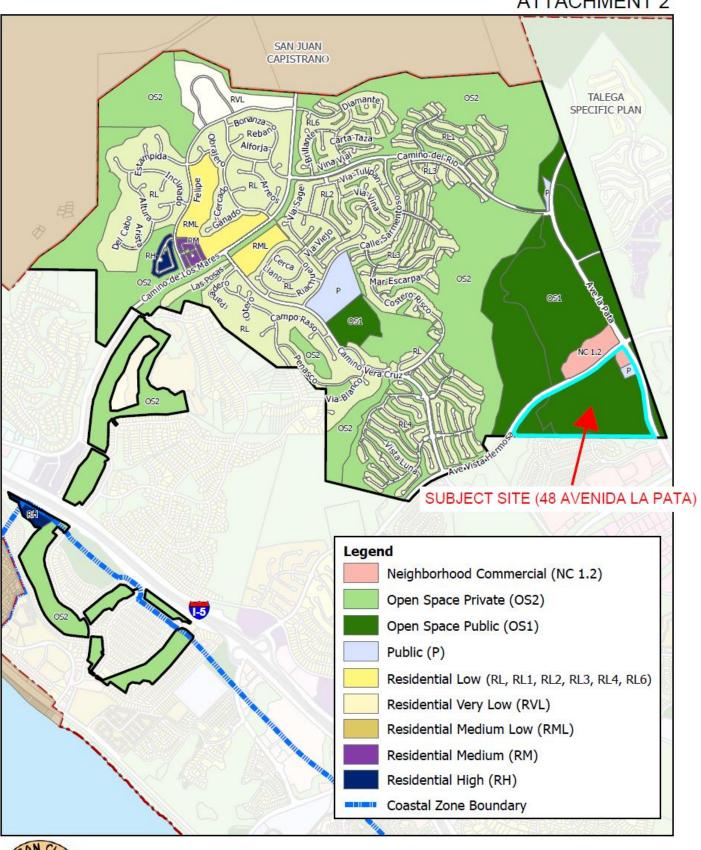



Scale: 1:23,619 0 1,250 2,500 Feet



### **RELEVANT GENERAL PLAN POLICIES AND DESIGN GUIDELINES**

### General Plan Policies & Goals

- UD-5.09. Public Buildings. We require Spanish Colonial Revival architecture for the
  development and major remodels of public buildings, and for the development and
  major remodels of visually prominent, non-residential, quasi-public structures such as
  churches, assembly halls, theaters and cultural facilities, except in those districts
  allowing for a different architectural style.
- UD-5.10. Scale and Massing. We require that the scale and massing of development be compatible with its surroundings and with the General Plan, applicable specific plan and or area plan.
- UD-5.18. Drought Tolerant/Native Species Landscaping. Ornamental plantings in new, non-residential development should consist primarily of drought tolerant and California native species. Only in small areas and special public locations, such as high-use areas of parks, should lawns or other high water use vegetation be used.

### BPR Element

- GOAL: Create and maintain safe, well-designed and high-quality parks and recreation facilities and programs that meet a wide range of local recreational, fitness and enrichment needs, and that promote community health and wellbeing.
- GOAL: Provide and maintain parks and recreation facilities with adequate spaces and amenities to meet the recreational and relaxation needs of existing and future residents.
- BPR-1.01. Programming. We program our parks and other recreation facilities for efficient and creative uses, consistent with the type of facility, user groups served and community needs, and with the Beaches, Parks and Recreation Master Plan [staff to provide link when developed].
- BPR-1.02. Users. We provide indoor and outdoor programs and facilities appropriate for a range of income levels, ages and abilities.
- BPR-1.05. Safety. We design and maintain park and recreation facilities to provide a safe experience.
- BPR-6.08. Social Interaction/Community Participation. We encourage enhanced social interaction, community participation in special events, youth sports and outdoor activities by developing and maintaining public facilities and spaces that promote health and wellness.

### General City Design Guidelines


- Projects should demonstrate sensitivity to the surrounding context and neighboring buildings.
- Develop compatible relationships between the topography, building placement, and existing open spaces of neighboring properties.
- Minimize potential surface drainage problems on neighboring properties, and provide adequate drainage on-site.
- Provide a clear circulation plan for automobiles, pedestrians, and service vehicles.
- Provide pedestrian circulation, pedestrian amenities, and bicycle facilities in all site plan proposals.
- Use planting to define outdoor spaces, soften the impact of buildings, and parking areas, screen parking and service areas from public view and create visual linkages to neighboring development.
- All development proposals should demonstrate sensitivity to the contextual influences of adjacent properties and the neighborhood. A diligent effort should be made to orchestrate careful relationships between old and new.
- Design buildings to be compatible in scale, mass and form with adjacent structures and the pattern of the neighborhood.
- Carefully design rear and side facades to be compatible with the principal facades of the building.
- Palm trees, hedges, and other plantings work with the building walls to define exterior living spaces. The landscape character of outdoor spaces is an integral part of the architecture. A common pattern is the sequence of street, landscaped entry court, then building.
- The building components are divided into parts scaled to human size.
- Ornament and sculptural detail are located where special emphasis is desired, such as at entrance and tiled patio areas.
- Outdoor spaces encouraged include courtyards, patios, plazas, covered walkways (arcades and colonnades), passages, gardens, trellised areas, verandas, balconies, roof terraces, and all other spaces that are enclosed or partly-enclosed
- Articulate new building forms and elevations to create interesting roof lines, and strong patterns of shade and shadow.
- Avoid long and unrelieved wall planes. As a general principle, relieve building surfaces with recesses that provide strong shadow and visual interest.
- Recesses may be used to define courtyards, entries or other outdoor spaces along the perimeter of a building.
- Projections may be used to emphasize important architectural elements such as entrances, bays, stair towers, balconies, and verandas.
- Varied roof heights are encouraged.

- Changes in roof orientation should be accompanied by plan offsets. Similarly, abrupt changes in adjacent heights require plan offsets to distinguish building forms.
- Create a visual balance in the relation between dimensions of buildings, their parts, and the spaces between and around them.
- Building proportions with a horizontal emphasis are generally desired, except in the use of accent tower elements. Avoid vertical proportions that exaggerate building height.
- Vary the spacing of building elements in facades.
- Carefully integrate signage with the design concept of the building and site. Signage should be consistent with the architectural character of the building.
- Locate and design building equipment to minimize visual impact on public streets and neighboring properties.
- Roof-mounted equipment should be screened from view from adjacent streets, properties, and pedestrian areas. Give special attention to buildings whose roofs are viewed from higher elevations. Integrate the rooftop equipment into the design of the roof. It is often possible to create a '%ell" within the structure so that the equipment is surrounded by pitched roof forms.
- Roof-mounted equipment should be painted so as to minimize its visibility.



## Salty Turf Mini Golf

SHEET INDEX	PROJECT SUMMARY TABLES	CODE DATA
01 General  T.0 Title Sheet  02 Arch  AT.0 Preiminary Site Plan A2.1 Caubhouse Plan A2.2 Kitchen Plan & Exterior Elevations A2.3 Roof Plan A3.0 Exterior Elevations A3.1 Exterior Elevations A3.1 Exterior Elevations A3.2 30 Views A4.0 Building Sections	Project Data  LOT AREA: 53, 138 S.F.  CLUBHOUSE: 1,541 S.F.  KITCHEN: 939 S.F.	Occupancy Group: A-3 Zoning Designation: FRSP General Plan Designation: OS1 Type of Construction: TYPE VB, FIRE SPRINKLERED* Number of Stories: ONE
PROJECT DIRECTORY		FIRE SPRINKLERED TO BE PROVIDED THROUGHOUT
Owner: City of San Clemente  Leasee: Salty Turf, LLC  Legal Description:		CODE INFORMATION- 2022 CBC - BASED ON 2021 IBC 2022 CBC - BASED ON THE 2020 NATIONAL ELECTRICAL CODE (NEC) 2022 CBC - BASED ON THE 2021 UPC 2022 CBC - BASED ON THE 2021 UPC 2022 CBC - BASED ON THE 2021 UBC 2022 CBC - BASED ON THE 2021 UBC 2022 CBC - BASED ON 1142 2021 UBC 2022 CBC - BASED ON 2021 IFC 2022 CAL GREEN BLDG - STDS - CODE GTY OF SAN CLEMENTE CODES AND ORDINANCES
TRACT: 573		Vicinity Map
BLOCK: S APN: 682-202-09  Job Address:  Vista Hermosa Sports Park. 43 Avenida La Pala San Clemente, CA 92673  Architect:  MICHAEL LUNA & ASSOCIATES, INC. MICHAEL LUNA, ARCHITECT		SITE

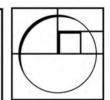

34932 Calle Del So

Beach, California

Phone: (949) 493-5200



ematic Design

Salty Turf Mini Golf


Title Sheet




Project No. 2024-03
Pict Date 09.25.24
B.D. Submittal
Bid Issue
Const. Issue
Revision
Revision
Revision
Revision

T.0

Users\Owner\Documents\MiniGolf\_central\_Duane-PC.rut

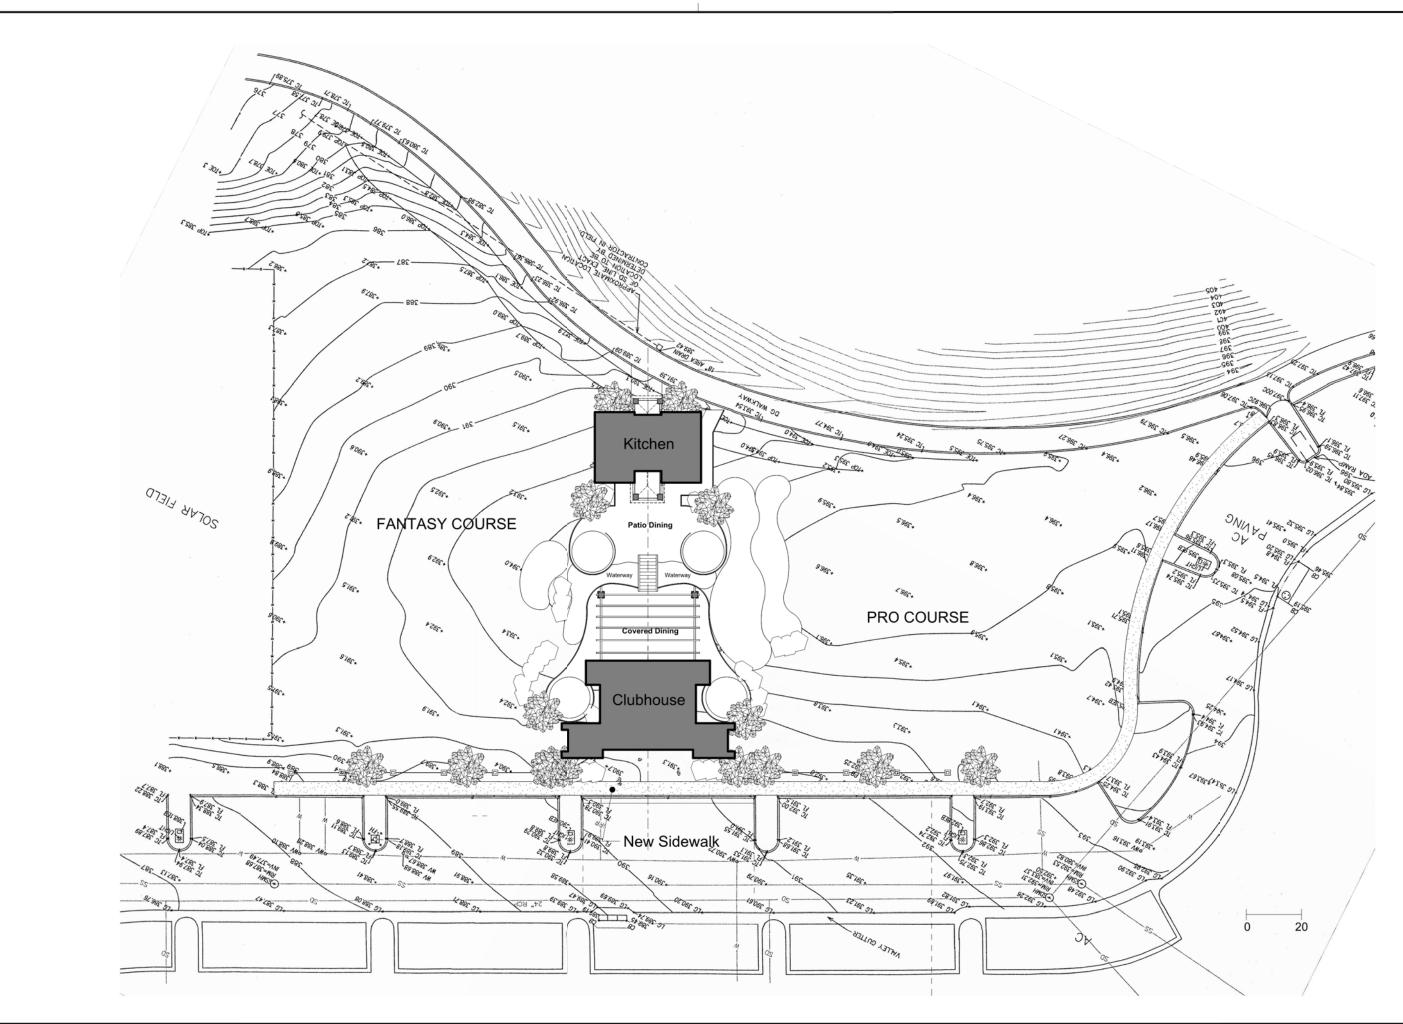

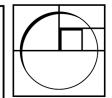

34932 Calle Del So

> Beach, California

Phone: (949) 493-520

#### MICHAEL LUNA & ASSOCIATES, ARCHITECTS, INC.

Project

Schematic Design Phase

Salty Turf Mini Golf

Sheet Title


Preliminary Site Plan




Project No. 2024-03
Plot Date 09.25.24
B.D. Submittal
Bid Issue
Const. Issue
Revision

Revision Revision Revision Revision

A1.0

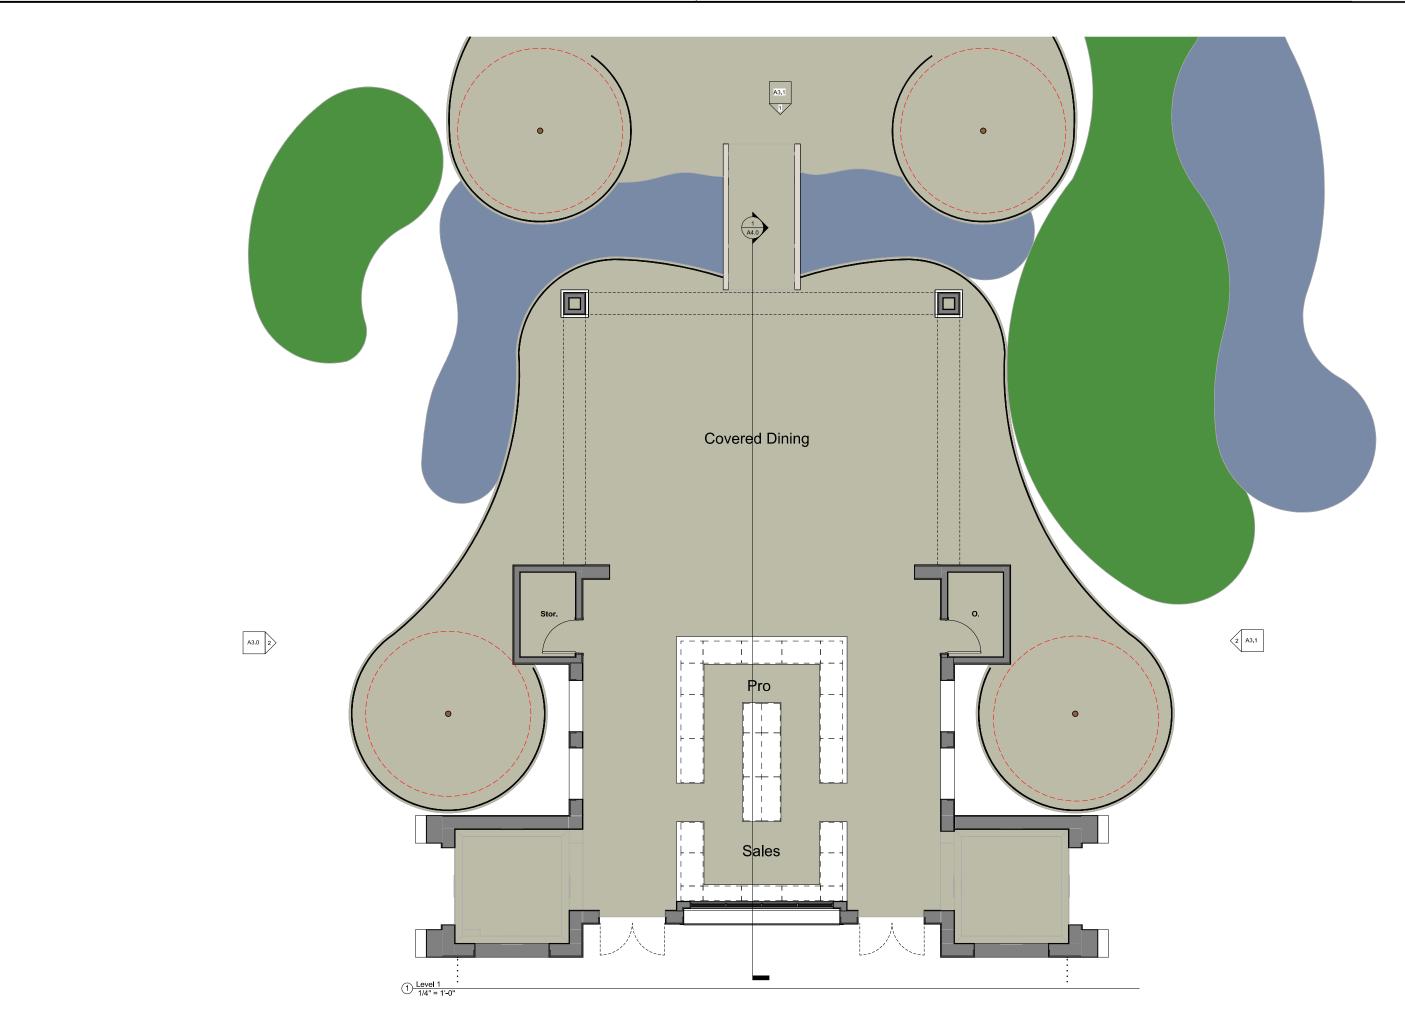

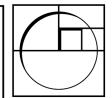

34932 Calle Del So

> Beach, California

Phone: (949) 493-5200

### MICHAEL LUNA & ASSOCIATES, ARCHITECTS, INC.

Project

Schematic Design Phase

Salty Turf Mini Golf

Sheet Title


Clubhouse Plan



Project No. 202
Plot Date 09.
B.D. Submittal
Bid Issue
Const. Issue
Revision

A2 1



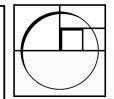

34932 Calle Del Sol

> Capistrano Beach, California

Phone: (949) 493-5200

### MICHAEL LUNA & ASSOCIATES, ARCHITECTS, INC.

Project

Schematic Design Phase

Salty Turf Mini Golf


Sheet Title


Kitchen Plan & Exterior Elevations



Project No. 2024-03
Plot Date 09.25.24
B.D. Submittal
Bid Issue
Const. Issue
Revision Ravision

A2.2

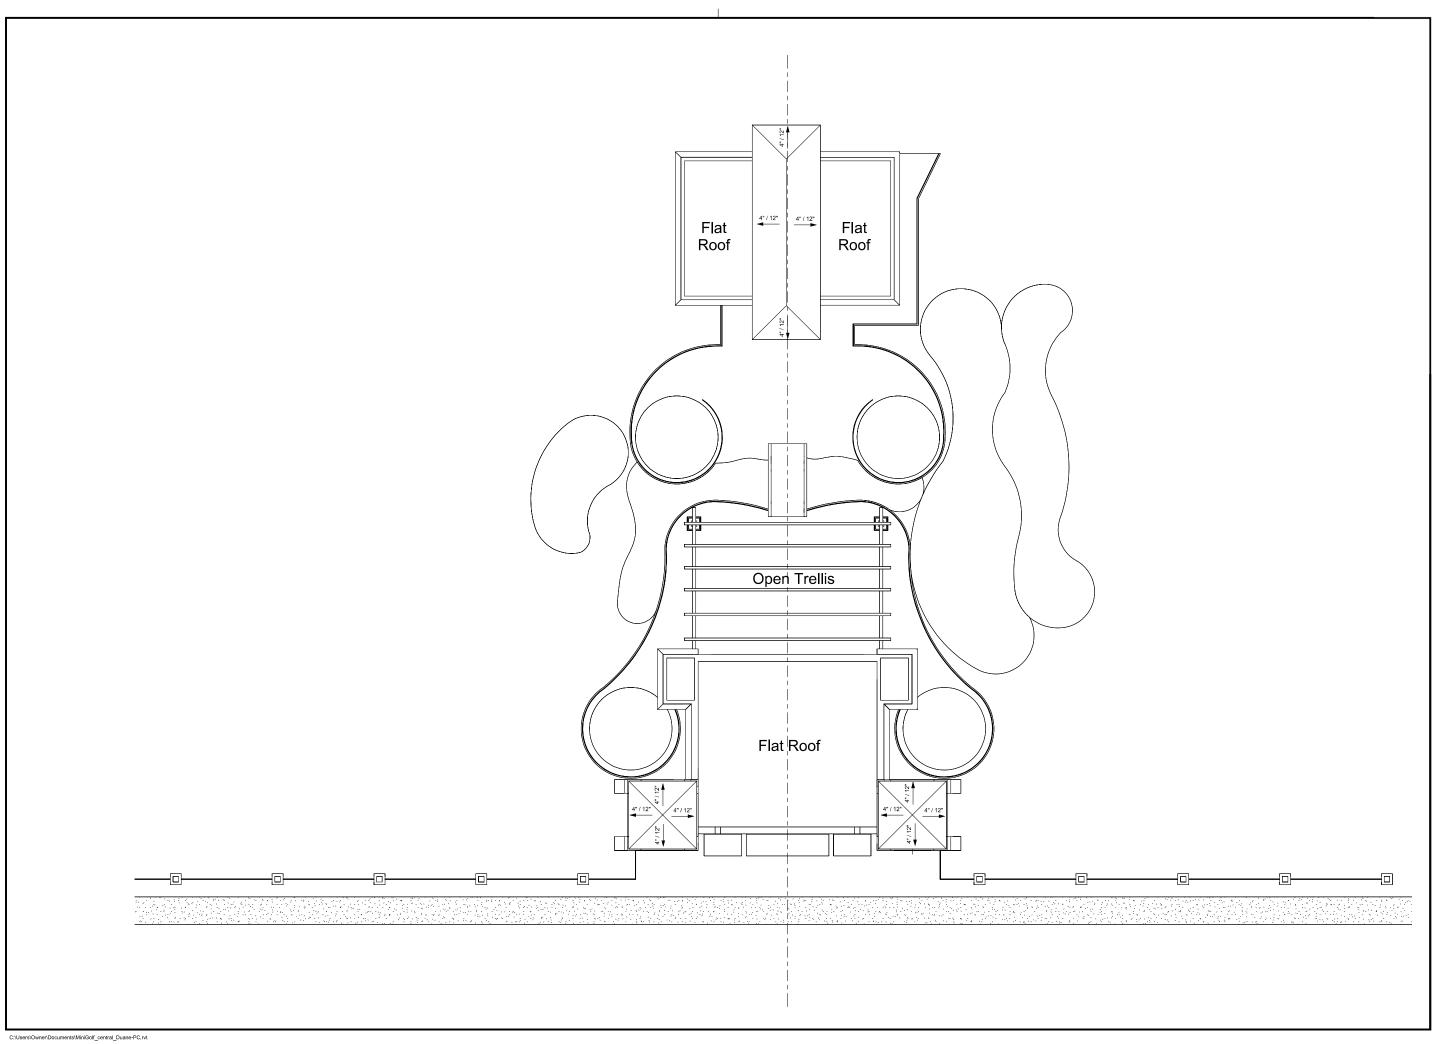

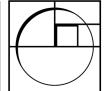

# MICHAEL LUNA & ASSOCIATES, ARCHITECTS, INC.

Schematic Design Phase

Salty Turf Mini Golf

Roof Plan










2 West 1/4" = 1'-0"

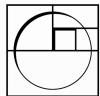

Calle Del Sol

Phone: (949) 493-5200

# MICHAEL LUNA & ASSOCIATES, ARCHITECTS, INC.

Schematic Design Phase

Salty Turf Mini Golf

Exterior Elevations



Project No.
Plot Date
B.D. Submittal
Bid Issue

C:\Users\Owner\Documents\MiniGolf\_central\_Duane-PC.rvt





## Michael Luna

Associates

Architect

Schematic Design Phase

Salty Turf Mini Golf

Exterior Elevations












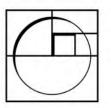

34932 Calle Del

Suite A,

Beach, California

Phone: (949) 493-5200

#### MICHAEL LUNA ASSOCIATES, ARCHITECTS, INC.

Project

Schematic Design Phase

Salty Turf Mini Golf

Sheet Ti


3D Views





Project No. 2
Plot Date 0
B.D. Submittal
Bid Issue
Const. Issue
Revision

Revision A Revision Revision

A3 2

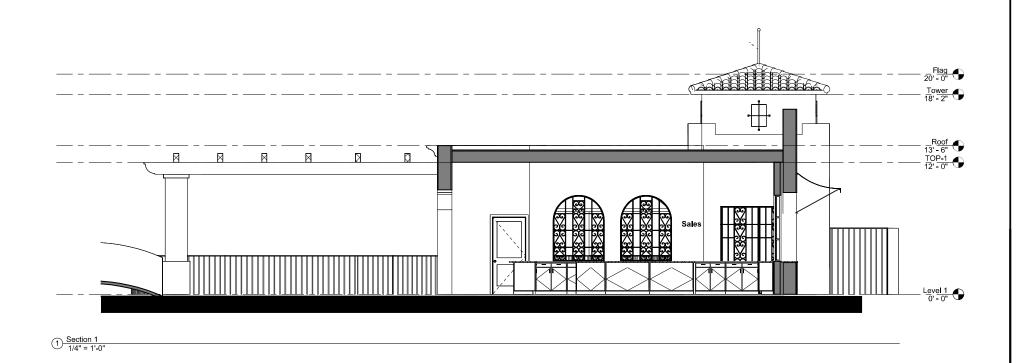

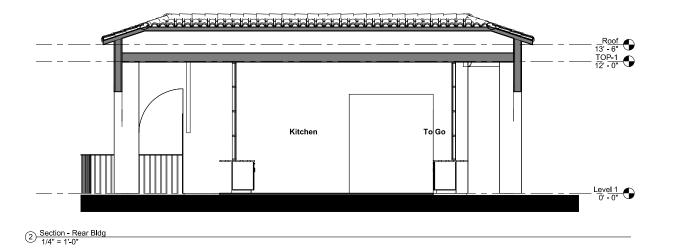

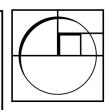

Calle Del Sol

Phone: (949) 493-5200

# MICHAEL LUNA & ASSOCIATES, ARCHITECTS, INC.

Schematic Design Phase

Salty Turf Mini Golf

Building Sections



C:\Users\Owner\Documents\MiniGolf\_central\_Duane-PC:rvt



