

Design Review Subcommittee (DRSC)

Meeting Date: March 13, 2024

PLANNER: Prepared by Chris Johnson, Senior Planner

SUBJECT: Conditional Use Permit (CUP) 23-197, Site Plan Permit (SPP) 23-199,

and Minor Exception Permit (SPP) 23-198, a request to remodel an existing office, construction of a new 2,705 s.f. multipurpose building with a 1,600 s.f. patio on the main level, a 3,040 s.f. unfinished basement, and demolition of an existing garage located at 702 Avenida De La Estrella within the Residential Medium (RM) Density

Zoning District.

BACKGROUND:

The applicant is requesting a revision to the original master plan entitlements SPP 06-027, CUP 08-030, MEP 08-270 for Cornerstone Church which was approved on August 20, 2008. The original entitlement included the approval of a second story over the existing church. The applicant has determined that the construction of a second story over the existing church creates too much massing and is now proposing to utilize that space in another location onsite in the form of a multipurpose building and unfinished basement.

Proposed Project

The requested modifications to the original approvals noted above include the remodeling of an existing office and the construction of a new multipurpose building to match the architecture of the existing church completed in March 20, 2015. An existing trailer located onsite would be replaced with a new multipurpose building of 2,706 s.f. with a 1,600 s.f. patio on the main level, and a 3,040 s.f. unfinished basement below. An existing onsite garage is also to be demolished. All new architectural elements and style will incorporate Spanish Colonial Revival architecture to match the existing church. The project is located within the Residential Medium (RM) Zone at 702 Avenida De La Estrella. Please refer to **Attachment 1:** Project Site.

The surrounding area is comprised of single and multi-family residential development with various architectural styles. Please refer Figure 1: Project Location and **Attachment 2:** Photographs of Existing Conditions.

Architecture

Although not required, the applicant is proposing Spanish Colonial Revival architectural for the new multipurpose building and modifications to an existing office which occupies the space of a former residential building. The overall design of the project is consistent with the City's adopted architectural style. The smooth white stucco finish, red tile roof, and various design elements help to create a theme consistent with Spanish Colonial Revival architecture. Refer to **Attachment 3:** Architectural Style-Inspiration Board, **Attachment 4:** Site Plan, **Attachment 5:** Project Plans for more detail.



Figure 1: Project Location

DRSC Review:

The project requires review by DRSC pursuant to San Clemente Municipal Code (SCMC) Section 17.16.100.1. DRSC review is required for Development Permits (DP) as it relates to site planning, parking lot design, setbacks, compatibility, and relationship with adjacent development. A review of physical improvements is required for projects which due to their scale, proximity to environmentally sensitive resource areas, or unique design features, require special discretionary consideration. The Development Permit process is intended to encourage site and structural development which 1) respect the physical and environmental characteristics of the site, 2) ensures safe and convenient access and circulation for pedestrians and vehicles, 3) exemplifies the best professional design practices, 4) encourages individual identity for specific uses and structures, 5) encourages a distinct community or neighborhood identity, and 6) minimizes visual impacts.

¹ The City's Municipal Code does not yet reflect the standards approved by the City Council through Ordinance no. 1759 in October of 2023. The Ordinance and associated code provisions can be found here in the interim: https://library.municode.com/ca/san_clemente/ordinances/code_of_ordinances?nodeId=1249271

ANALYSIS:

Development Standards

The project complies with most development standards of the RM zone, as shown below in Table 1: *Compliance with Development Standards*. The only exception is for improvements to a portion of the office building within the front setback. Development plans indicate that the proposed office expansion would not comply with the street side setback. Staff will continue to work with the applicant to explore options for the office expansion.

Table 1: Compliance with Development Standards

Standards for RM	Zoning Ordinance	Proposed	Compliance
Setbacks (Minimum)			
Front ² (Estrella)	15'	7' (existing office)	Pending: Staff is evaluating whether an existing porch can be enclosed
Side (Interior)	5'	5'	Yes
Street Side (El Oriente)	10'	3' (existing church)	Yes: Legal non- conforming
Rear	5'	5'	Yes
Building Height (Maximum)	25'	25'	Yes
Parking (Minimum)	25 stalls	25 stalls	Yes
Lot Coverage	55%	29%	Yes

RECOMMENDATIONS:


Staff and the applicant request DRSC feedback on the proposed architectural design and a determination on whether the project may be forwarded to the required public hearing. The project requires review by the Planning Commission due to the modified request of the previous entitlements, per SCMC 17.12.180 - Applicant Requests to Change Approved Applications.

² "Front lot line" means the narrowest dimension of a lot fronting on a street. The parcel incorporates multiple lots, which individually have their narrowest frontage on Avenida De La Estrella. As part of the original Master Plan approval, it was established that the Estrella frontage constitutes the "front lot line."

ATTACHMENTS:

- Project Site
 Photographs of Existing Condition
 Architectural Style-Inspiration Board
- 4. Site Plan
- 5. Project Plans

Attachment 1

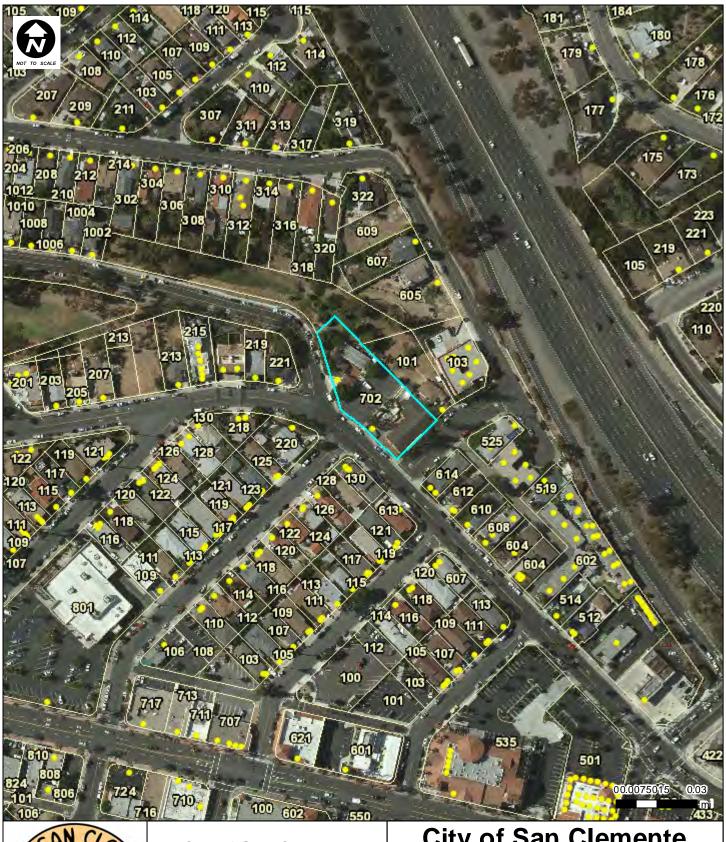



City of San Clemente

910 Calle Negocio, Suite 100 San Clemente, CA 92673 Tel (949) 361-6100 Fax (949) 361-8316

City of San Clemente

Cornerstone Church 702 Avenida De La Estrella **Project Site**

ATTACHEMENT 2: PHOTOGRAPHS OF EXISTING CONDITION



Photo 1: View Looking North from Avenida De La Estrella at the Existing Church



Photo 2: View Looking North from Avenida De La Estrella Toward the Project Site



Photo 3: View Looking Northeast Toward the Project Site from E. Escalones



Photo 4: View Looking East Toward the Project Site from Avenida De La Estrella

ATTACHMENT 3

INSPIRATION

ARCHITECTURAL STYLE- SPANISH COLONIAL REVIVAL
















ATTACHMENT 4

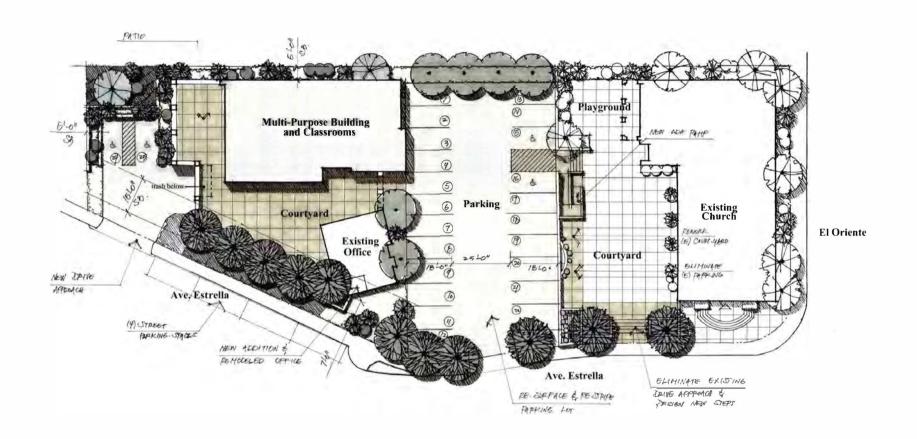

Site Plan

Cornerstone Church San Clemente, California 11-21-23





CLEMENTE, CAL ORNIA F

ABBREVIATIONS

AND
ANGLE
AT
CENTERLINE
DIAMETER OR ROUND
POUND OR NUMBER
EXISTING ANCHOR BOLT
ARCHOR BOLT
ARCHOR BOLT
ACOUSTICAL
ARCA DRAIN
ADJUSTABLE
ABOVE FINISH FLOOR
AGGREGATE
ALUMINUM
ANGLE
APPROXIMATE
ARCHITECTURAL
ASPHALT A.B.
ABV.
ACCUS.
A.D.
ADJ.
A.F.F.
ACGR.
ALUM
/_
APPROX.
ARCH_
ASPH_
ASPH_

BOARD BITUMINOUS BUILDING BLOCK BLOCKING BOLT BEAM BGTYOM BD. BITIM. BLDG. BLK. BLKG. BLT BM. BOT. BOTTOM

CARNET
CATON BASIN
CRUENCE
CATON BASIN
CRUENCE
CAST IRON
CONSER GUARD
CELUNG
CAUST IRON
CONTROL
CONTRO

CAB
C.B.
CEM.
CIIR.
C.J.
C.G.
C.G.
C.G.
CLR
C.O.
CONC.
CONC.
CONN.
CONST.
CONF.
COR.
COR.
COR.
COR.
COR.
CORT.
CONT.
CONTR.
CONTR.
CONTR.
CONTR.
COTR. DOUBLE
DEPARTMENT
DEPARTMENT
DENNING FOUNTAIL
DETAIL
DIAMETER
DIAMETER
DIAMETER
DOOR OPENING
DOOR
DOOR OPENING
DOOR
DOORSPOUT
BRY STANDIPPE
DISHMASHER
DRAWNINGS
PRAWER DBL DEP1 D.F. DET. DHA. DIM. DN. D.O DIR. DS. D.S.P. DWG'S DWG'S DWR.

EAST
EACH
DRINK FOUNTAIN
EXPANSION JOINT
LEVANON
ELECTRICAL
ELEVATOR
ELEVATOR
ENGLERENCY
ENGLERENCY EL.
ELEC.
ELEV
EMER.
ENCL.
E.P.
EQPT.
E.W.C.
EXST.
EXP
EXPO.
EXT.

PRE ALAEM
FALT BAR
FLOOR DAWN
PRE CETIMOLISHER
PRE CHIMOLISHER
FRIEDRICH FLOOR
PRINCH FLOOR
PRINCH FLOOR
PRINCH GOAGE
FLOOR
FL F.A.
F.B.
F.B.
F.E.
F.E.
F.E.
F.G.
F.H.C.
FULOR
F.O.C.
F.O.S.
FPRF
FRAN'G
F.T.
FIG.
FURR.
FURR.
FURR.

GALICE GALVANIZED CRAB BAR GLASS GROUND GRADE GYPSUM GYPSUM BOARD GYPSUM BOARD H.B. H.C. HDWD. HDWE. H.M. HORIZ. HR. HT. H.V.A.C HORZ

PRCST.
PLAM.
PLAS.
PLYMD.
PNIL
PID
PLUMB.
PLYMD
P.
PR.
PT.
PREFAB
P.T.O.
P.T.O./R JANITOR JOINT

N. N.I.C. NO. OR # NOM. N.T.S.

PTN.
P.T.R.
O.T.
R.
RAD.
REF.
REFR
REV
REINIF
RGCO.
RESIL
RM.
R.O.
R.WD.
R.WL.

MAXIMUM MEDICINE CABINET MACHAE BOLT MECHANICAL MEMBRANE METAL MANUFACTURING MANUFACTURING MANUFACTURING MINIMUM MISCELLAHEOUS WASONRY OPENING MULLION NORTH NOT IN CONTRACT NUMBER NOMINAL NOT TO SCALE OVER
OVERALL
OBSCURE
ON CENTER
OUTSIDE DUMBETER (DIM.)
OFFICE
OVERHEAD CASHET
OPENING
OPPOSITE

POPULATE
PRECAST
PLATE
PLASTIC LAMINATE
PLASTIC PLASTIC
PLASTIC
PLASTIC
PLASTI

QUIABRY TILE
ROSP
RADIUS
RADIUS
RADIUS
RADIUS
RODO DRAM
REFERENCE
REFROEBATOR
REFROEBATOR
REFROEBATOR
REGURED
REGURED
REGURED
REGURED
REGURED
REGURED
ROSP
ROUNG
RAIN WATER LEADER

S.C. S.C.D. SCHED. S.D. SCHED. S.P. S.F. SH. SHR. SHI. SM. SKYLT. SL. SKYLT. SL. S.N.R. SPEC. SO. S.SK S.S. STD. STEL STOLE ST SPACE
SPECIFICATIONS
SOUANE
SERVICE SINK
STANLESS STEEL
STANDARD
STEAMDARD
STEEL
STRUCTURAL
STRUCTURAL
STRUCTURAL
STRUCTURAL
SUSPENDED
SOULD WOOD
SYMMETRICAL INF OF CURB
RESPICIONE
TERRAZZO
TONIGUE AND GROOVE
THICK
TOP OF CURB
TOP OF PARKAPET
TOP OF PARKAPET
TOMET PAPER DISPENSER
TREAD
TREAD TELEVISION TOP OF WALL TYPICAL

VERT VEST

DESIGN DATA

JRISOKTION: ZONE RM CONSTRUCTION TYPE: V-B OCCUPANCY: A-3/B-1 STORIES: 1 (OFFICE), 1-BASEMENT MULTI PURPOSE SETBACK PROVIDED: FRONT SB 15'-0" T-O" (existing at office) REAR SS 5'-0" 5'-0" SIDE SB 5'-0° 5:-0" SIDE/STR. 10'-0"

5'-0" BLD'G. HGT FROM NG 25'-0" 25'-0" (TONER)-40'-0" LOT COV 8,367.00 S F (29.13%)

LEGAL DESCRIPTION:

APR 692-102-21, 692-102-22 & 692-102-23

LOTS: 2, 12 - 16

BLOOK: 1

OTT: SAN CEMENTE

COUNTY: DOMAGE

SQUARE FOOTAGE CALCULATION:

ENSTING OFFICES F ADDITION TO OFFICE 840 00 5 F TOTAL

NOT MALTI PLRIPOSE

UNPASHED BASONENT

PATIG

DISTING MAIN CARROL

PATIGOTO

PA 612005 F 270250 5 F. 3.040.00 5. F

PARKIN]

RELIAND FOR FLANNING CODE SECTION 1764 050 CHURCHES

1 FOR 1 SEATS IN SANCLARY 100 SEATS, 25 PARKING SPACE Existing 24 Provided 26 (eliminate 5 from upper petio)

SCOPE OF WORK:

WE ARE REQUESTING A REVISION TO THE ORIGINAL MASTER PLAN UPDATED ON DECEMBER 4, 2019

THE DISTING OFFICE MULL BE REMODELED, AND THE NEW BENTERIOR. ARCHITECTURE MULL MATCH THE EXISTING CHURCH BUILDING COMPLETED MARCH 20, 2015 (SPANISH COLONIAL REVIVAL). ME MULL ALSO REPLACE THE EXISTING TRALIER AND BUILD A PERMANENT BUILDING IN TIS PLACE, THE ORIGINAL MASTER PLAN HAD APPROVED A SECOND STORY, WHERE THE NEW CHURCH BUILDING IS TODAY. TOO MUCH MASS, THE MEN MULT PURPOSE BUILDING MULL BE 3,040,00 S. F. ON THE MAIN LEVEL MYTH AN INFINISHED BASSEMBIT, STYLE OF ARCHITECTURE MULL MATCH THE OTHER BUILDINGS, WE MILL DEPONDED THE MEST MULL MATCH THE OTHER BUILDINGS, WE MILL DEPONDED THE MEST MULL MATCH THE OTHER BUILDINGS.

PROJECT TEAM:

OWNER: NECHITECT

Solls ENG.

PARKING DEMAND SUMMARY

	State of the State of			
584	days/hours	size	parking ratio	parking requattendens
Church Services	5un.1 * services 9:00-10 15 5un. 2 ¹⁰ service 10:45-12:00	2,025.00 S.F	1 per 4 seats 100 seats	(25) = service 75 avg. >= service 50 avg.
III Buen Pactor	Sun 10:45-12;00	1.350.00 S. F.	1 per 4 seats 40 seats	(10) 25 avg.
Church Office	Tues Wed, \$ Fri.:0:00 -3:00	600.00 S.F.	1/250	(3)
Bible study's	Mon., Ned , Thur , & Set 7:00-9:00 PM, 10:00 am-noon	1,350.00 SP	1 per 4 seats 40 seats	(10) 25 avg.

50% of El Buen Pastor's congregation waks to our church. El Buen Pastor has several people that go to our first service that will go to El Buen Pastor's service at 10.45 an Cornerations Church also uses "Farmers and Merchants" parking this is allowed as a gentlement agreement with the Bank

SHEET INDEX :

VICINITY MAP

T-1 TITLE SHEET

COUNTY FROM THE SHEET COUNTY SHEET PLAN

COUNTY SHOULD SHEET SHEET SHEET PLAN

COUNTY SHEET SHOULD SHEET SHEE

PROJECT NUMBER

CORNERSTONE (708 AVENIDA DE LA ESTRELLA SAN CLEMENTE, CALIFORNIA

MILESTONES / REVISIONS

Studio

(949) 388-5300 PHONE (949) 388-3330 FAX TUDIO6ARCHITECTS COI

BOBERT WILLIAMS

PROJECT CONTACT

PROJECT TEAM

CORNERSTONE CHURCH
708 AVENDA DE LA ESTRELLA
SAN CLEMENTE CALIFORNIA
PHONE NUMBER
FAX NUMBER

ARCHITECT MANAGER CLIENT


CHURCH


ICENSE STAM

SHEET TITLE SHEET

SHEET NUMBER

T-1

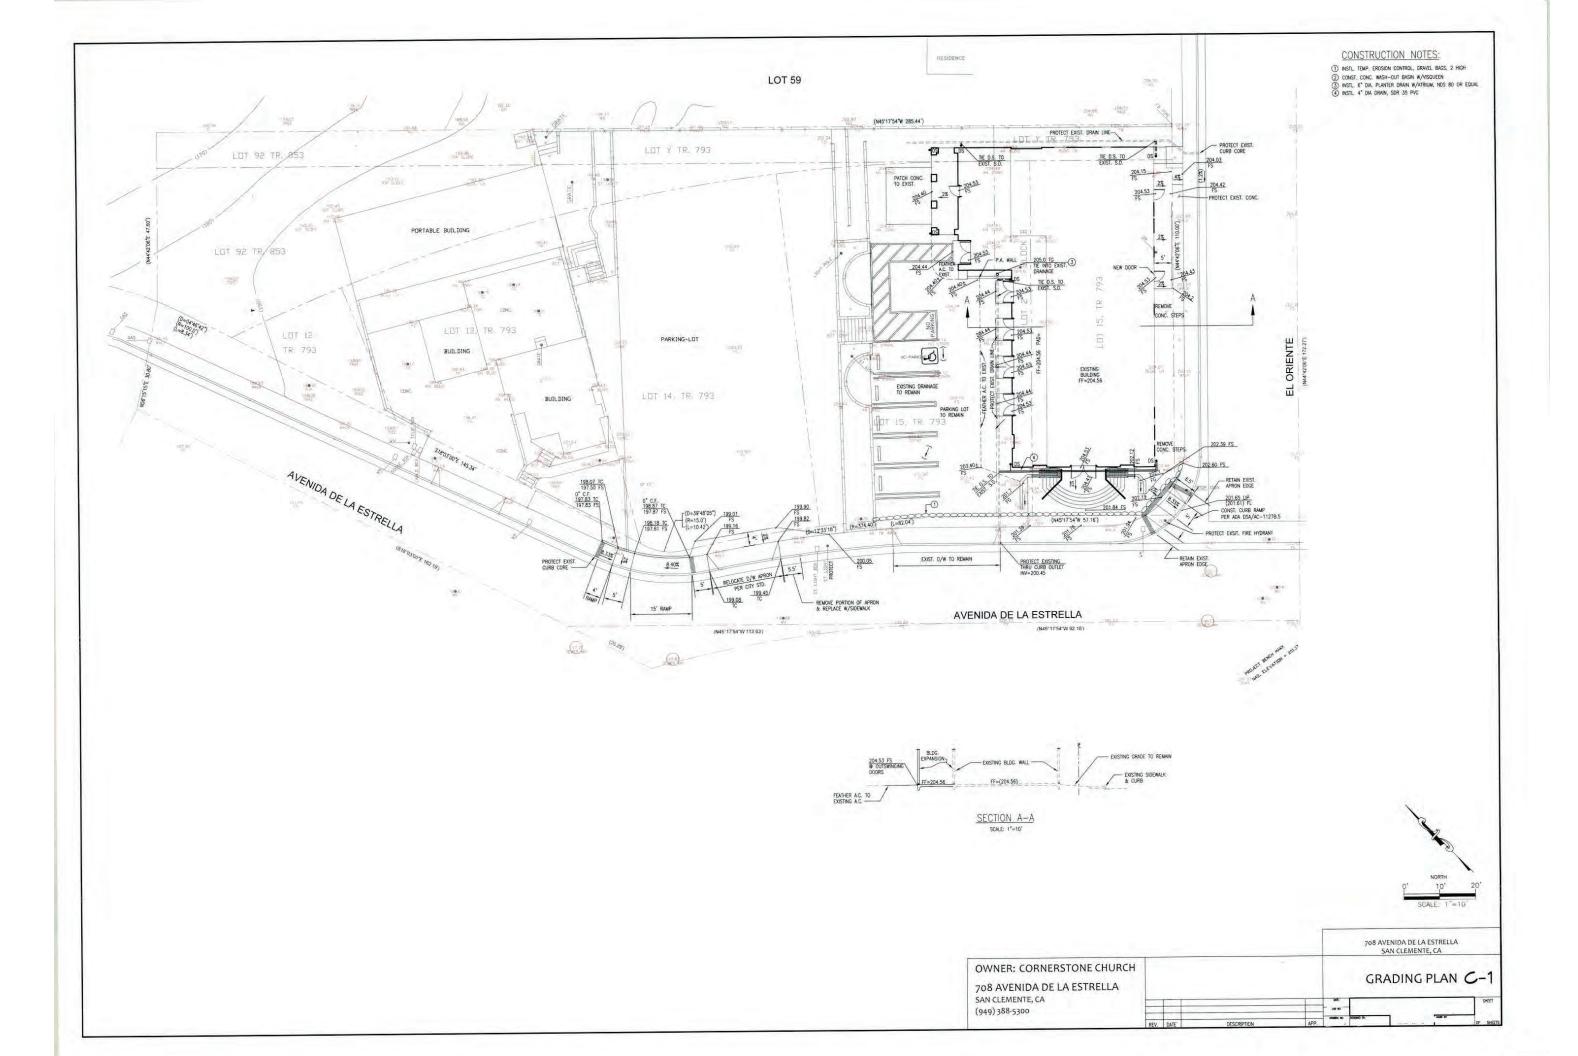


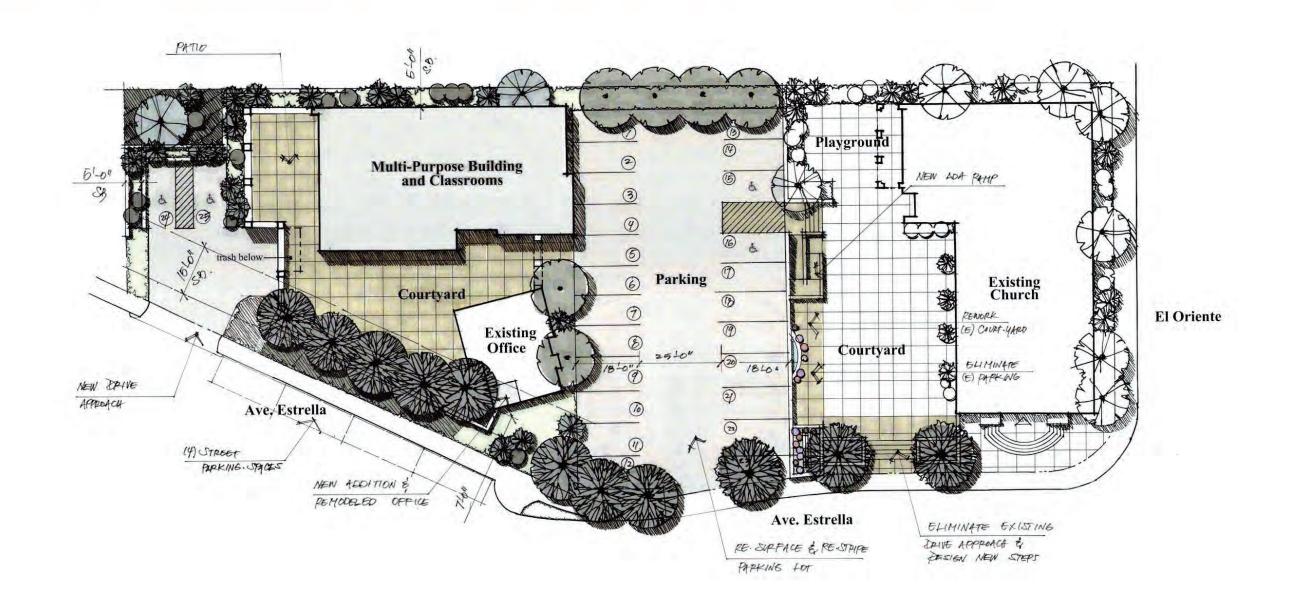


Site Plan

Cornerstone Church San Clemente, California 11-21.23



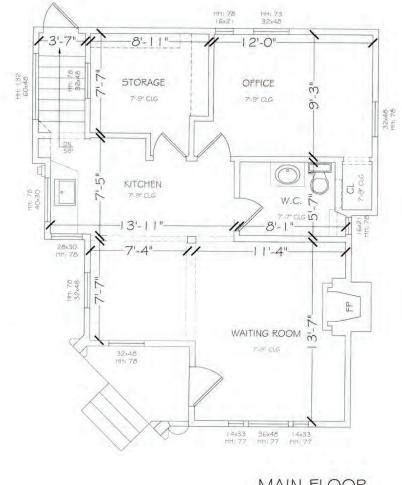


MAIN FLOOR

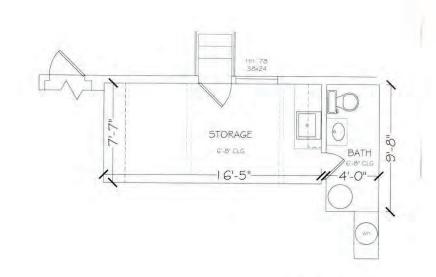


BASEMENT EXISTING OFFICE PLAN
SUGGE-1464

SAN CLEMENTE, CALIFORNIA




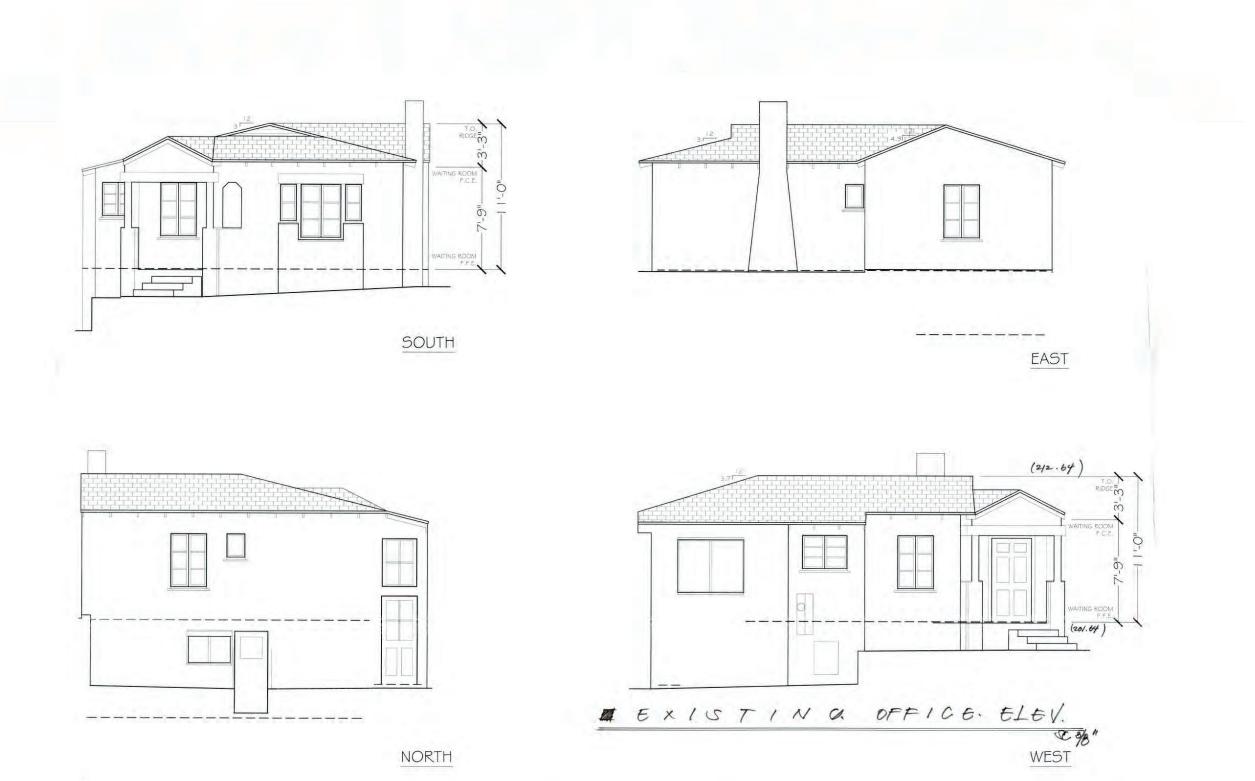


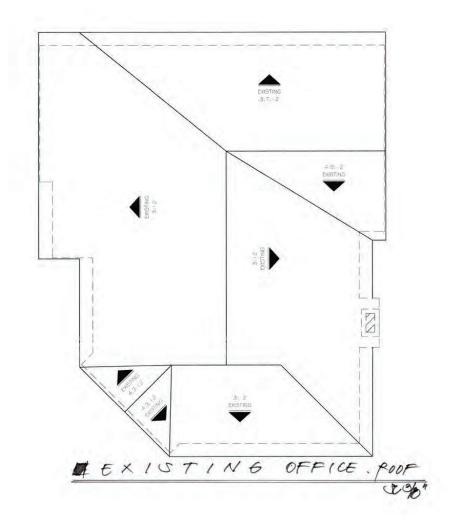

CORNERSTONE CHURCH PHASE II



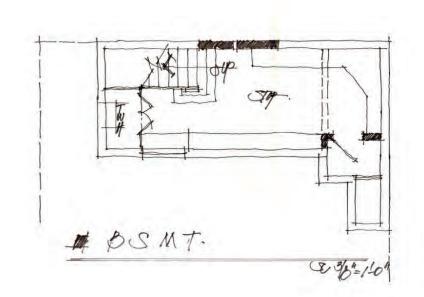

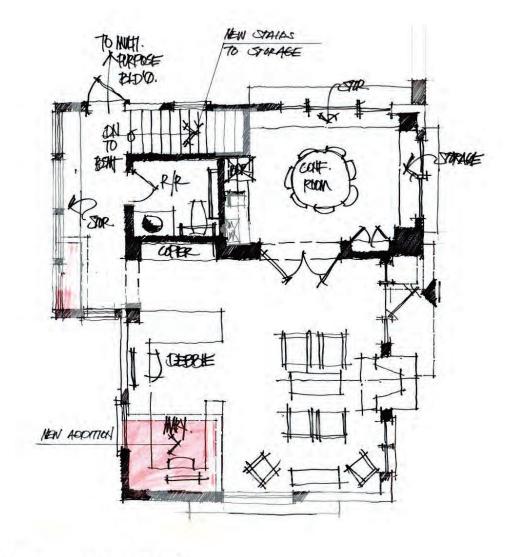

NEW. OFFICE. LAYOUT.

EXISTING

EXISTING


EXISTING


MEMO.

CORNERSTONE CHURCH PHASE !!

Studio

STUDIO 6 ARCHITECTS, INC.
ARCHITECTURE + PLANNING
2753 CAMNO CAPISTRAVO, SUITE A 100
(1949) 388-3300 FROME
(1949) 388-3305 FAX
STUDIORARCHITECTS COM

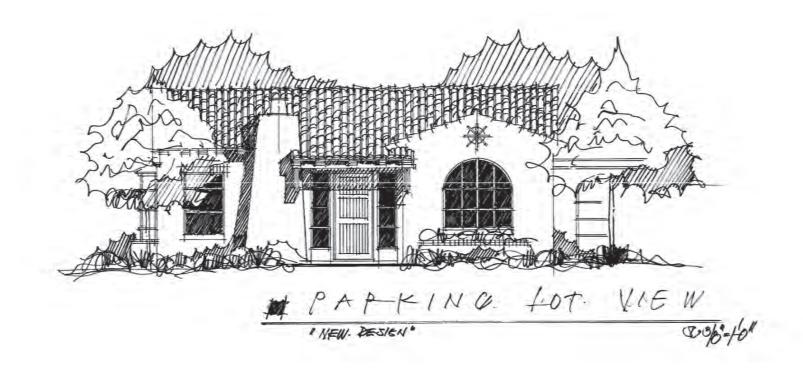

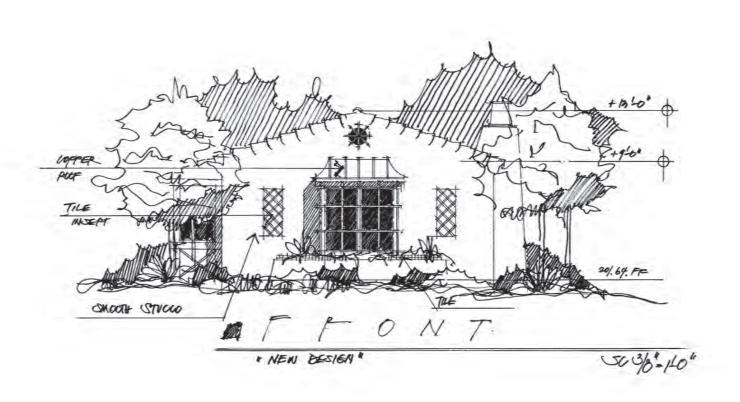

CORNERSTONE CHURCH PHASE II

SAN CLEMENTE, CALIFORNIA





front elevation




right-side elevation


Office Building

CORNERSTONE CHURCH PHASE

SAN CLEMENTE, CALIFORNIA




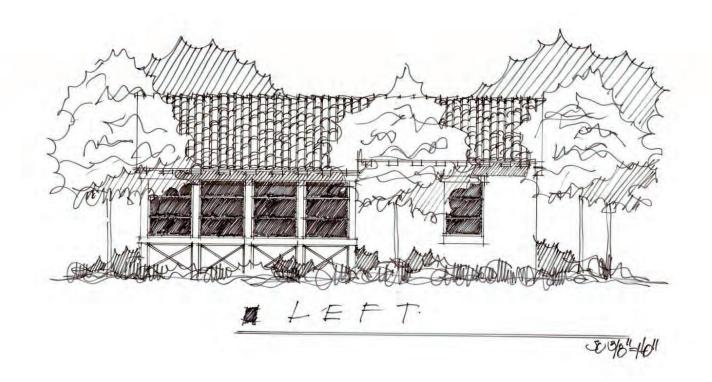

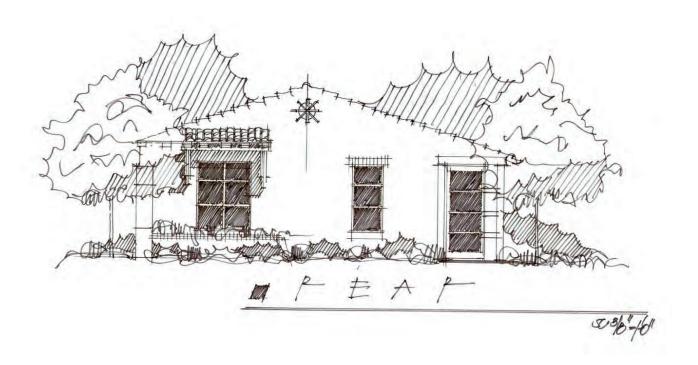

CORNERSTONE CHURCH PHASE ||
SAN CLEMENTE, CALIFORNIA


STUDIO 6 ARCHITECTS, INC.
ARCHITECTURE + PLANNING
2753 CAMINO CAMISTRANO SUITE A100
(1949) 386-3330 FAX.
STUDIOBARCHITECTS COM

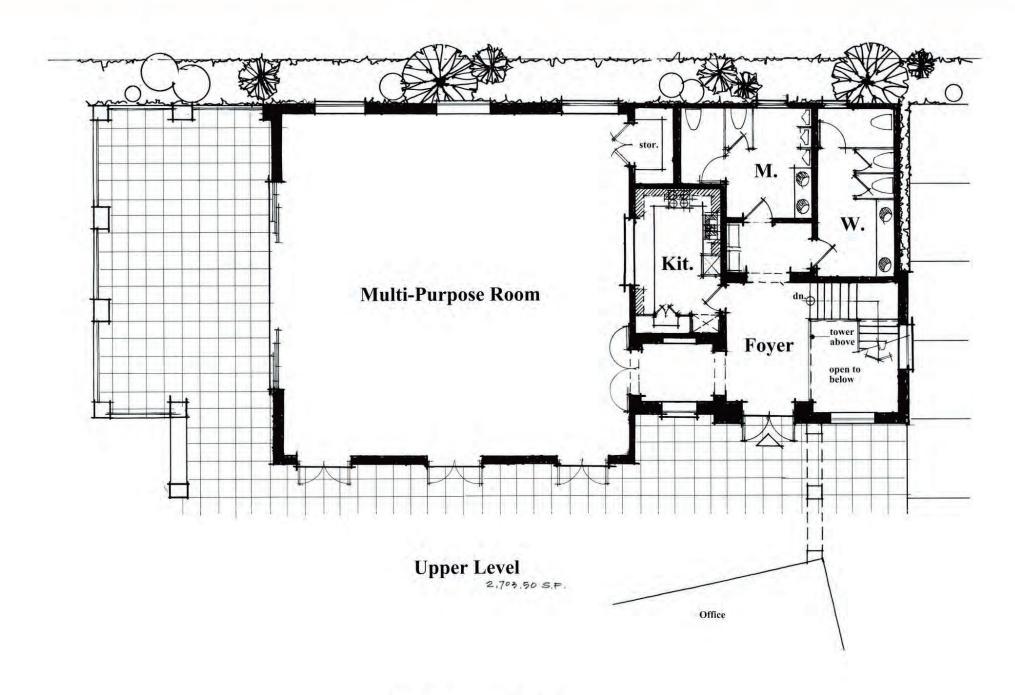

Multi-Purpose Building

Cornerstone Church San Clemente, California 1/4"=1'




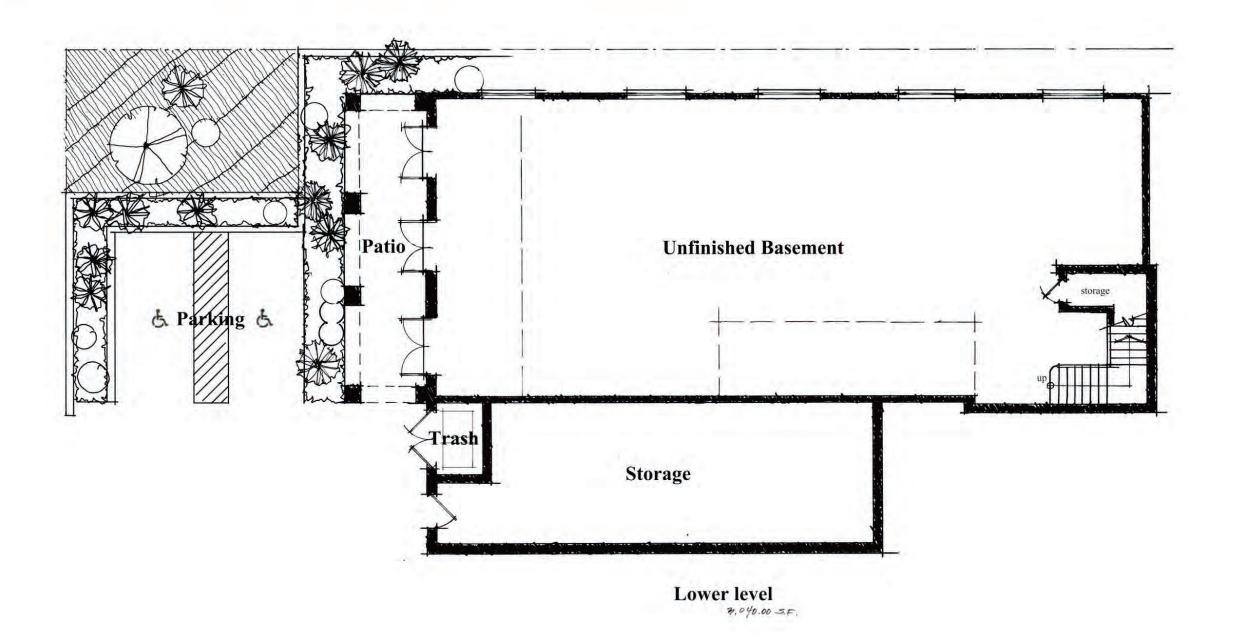

Multi-Purpose Building


Cornerstone Church San Clemente, California 1/4"=1' 11.06.23




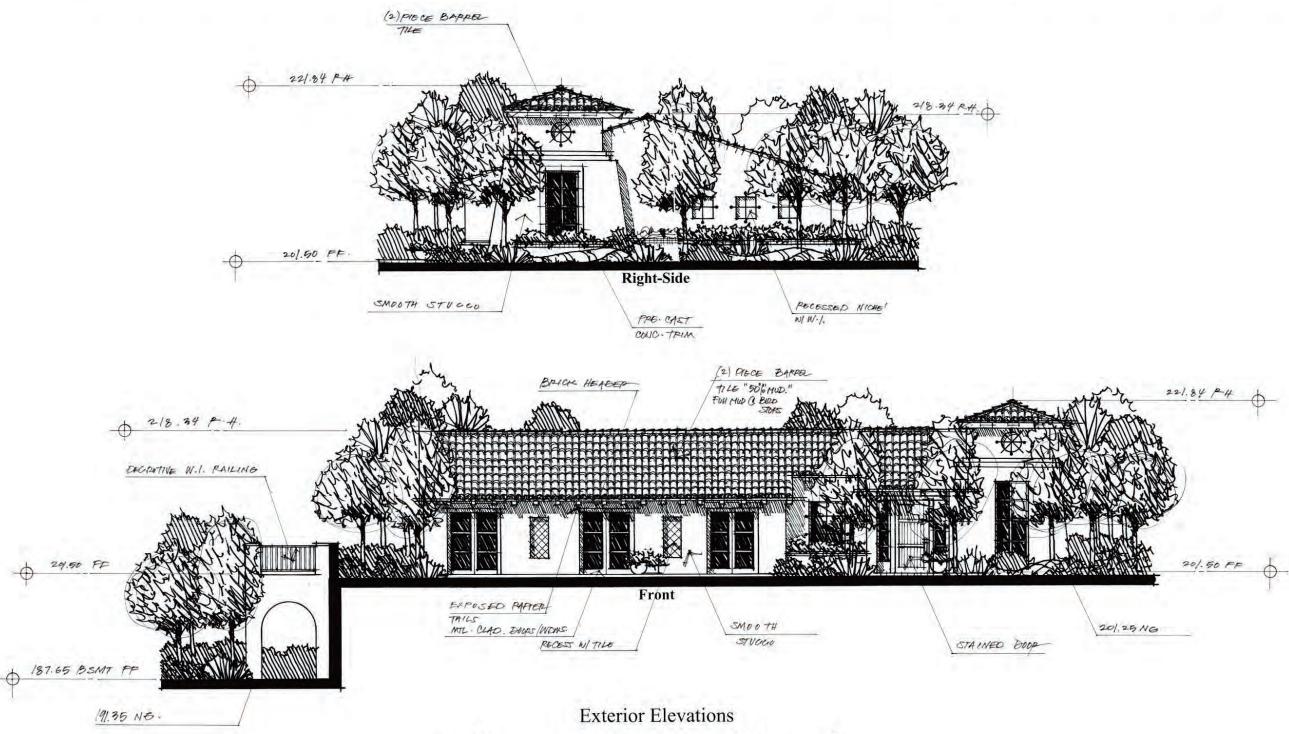

Cornerstone Church San Clemente, California 11.07.23




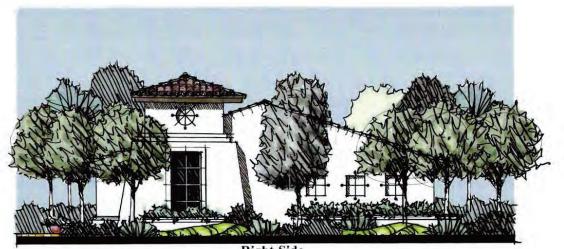

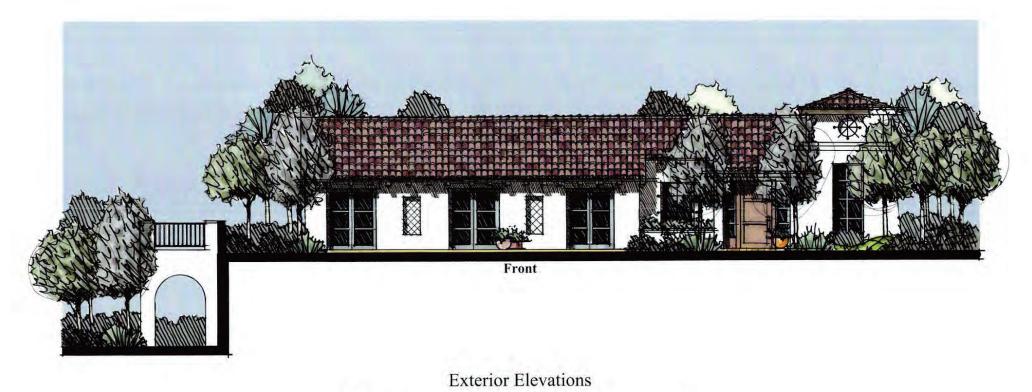

Cornerstone Church San Clemente, California 1/4"=1' Clemente, California



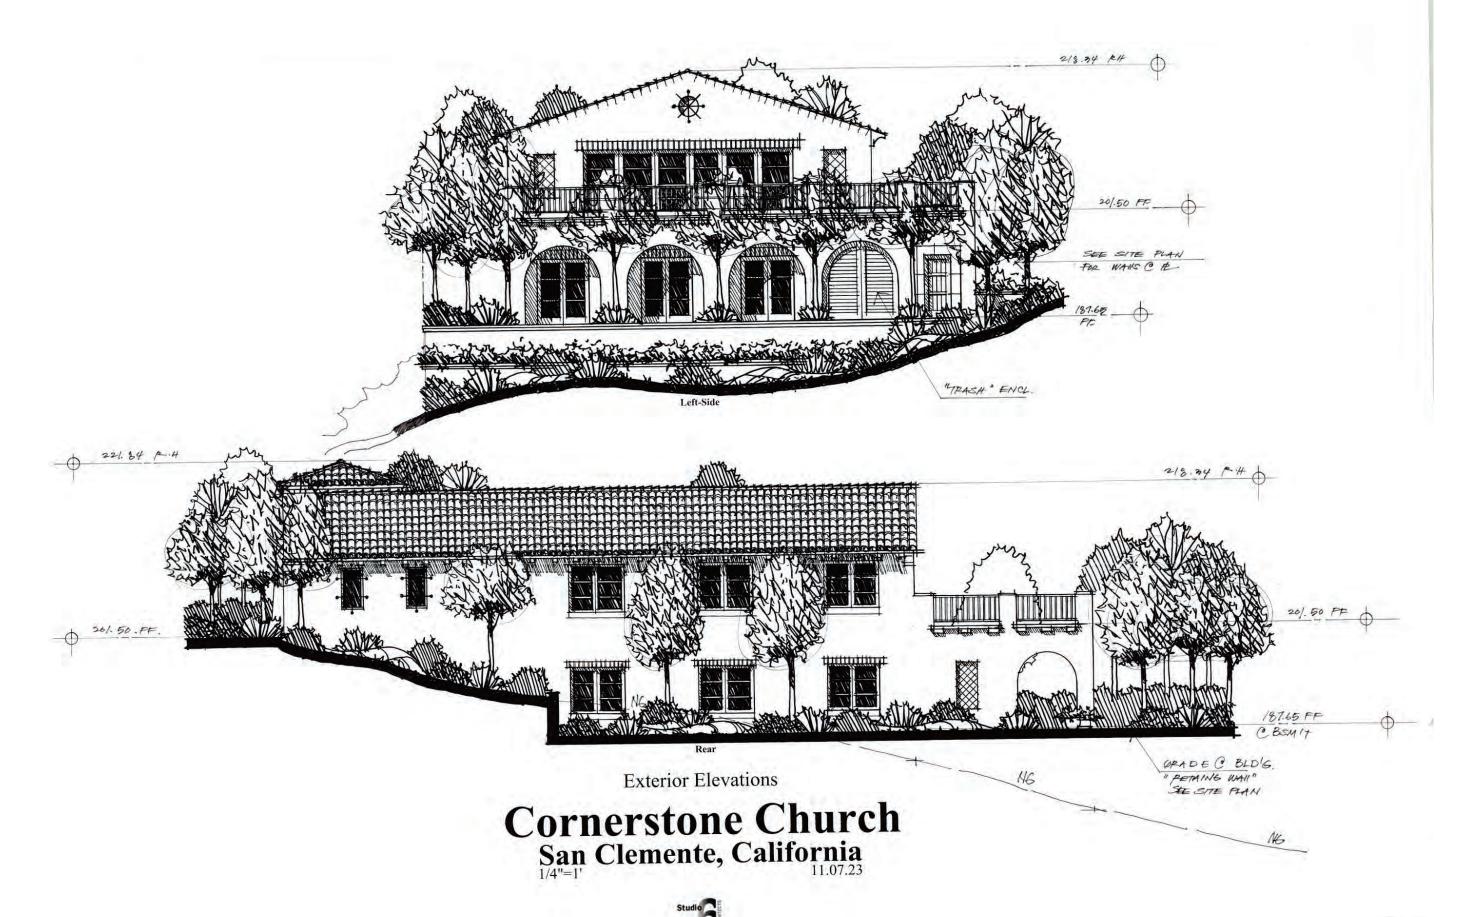






Exterior Elevations

Cornerstone Church San Clemente, California 1/4"=1' 11.07.23



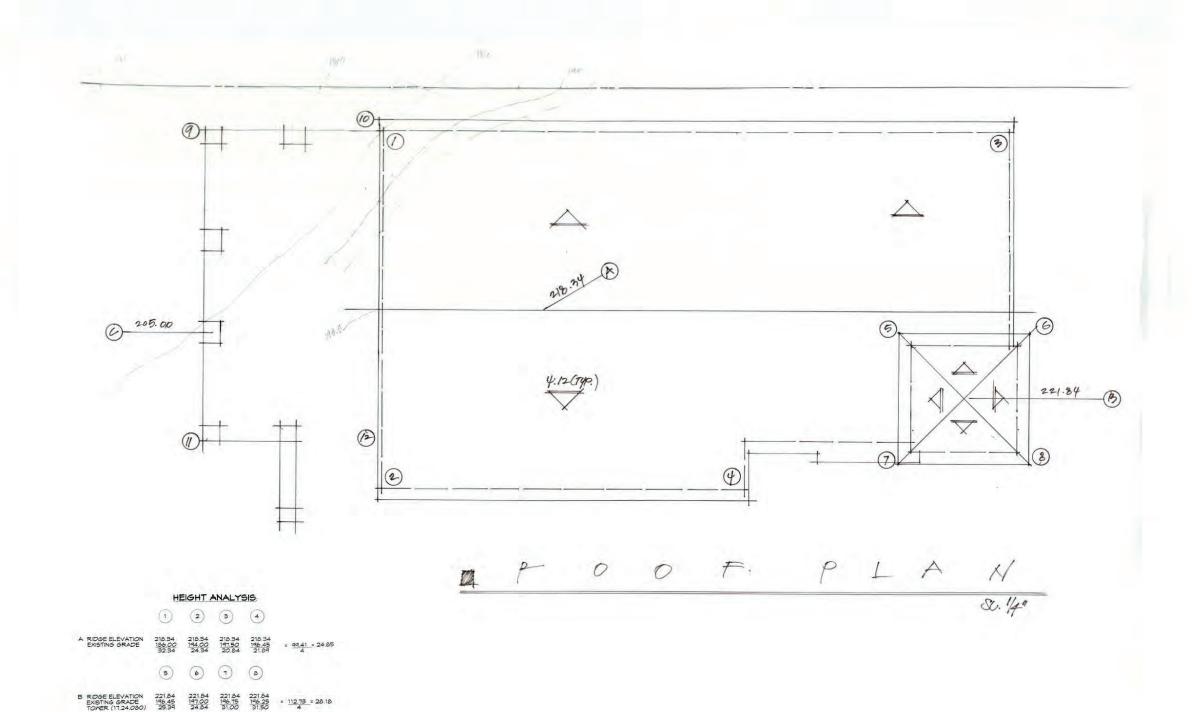

CORNERSTONE CHURCH PHASE II

9 00 11 12

C RIDGE ELEVATION 205.00 205.00 205.00 205.00 EXISTING GRADE 175.00 186.00 192.50 192.50 = 71.00 = 17.75 17.00 17.75 17.

SAN CLEMENTE, CALIFORNIA

