AGENDA ITEM: 2-A



Design Review Subcommittee (DRSC)

Meeting Date: September 27, 2023

PLANNER: John Ciampa, Contract Planner

SUBJECT: Conditional Use Permit (CUP) 21-268, AT&T Wireless

<u>Telecommunications Facility</u>, a request to establish a new 20-foot tall monoeucalyptus stealth wireless facility. Ground improvements include expansion of an existing Verizon equipment enclosure for AT&T equipment adjacent to a City

water tower at 4159 Costero Risco.

BACKGROUND:

The project site is located on City property in the Private Open Space zone of the Forster Ranch Specific Plan (FRSP P-OS2). The site is improved with a City water tower and a Verizon wireless facility consisting of an appurtenant equipment enclosure and an existing 20-foot tall monoeucalyptus wireless facility. The proposed AT&T facility would be located 50 feet to the northeast of the Verizon site and 74 feet to the southeast of the existing ground equipment enclosure. The project site is located approximately 50 feet below the ridgeline and 250 feet from the adjacent Forester Ranch Ridgeline Trail.

The project proposes to construct a new 20-foot tall monoeucalyptus wireless facility that would be constructed on the slope adjacent to a City water tower. The purpose for the project is to close a significant gap in coverage and capacity issues at this location and the surrounding community.

Based on a site visit conducted on July 14, 2023, and review of applicant provided photo simulations (Attachment 4), no impact to ridgeline views were observed and staffs position is that the project complies with the Hillside Development Ordinance. The project as proposed, generally complies with the design specifications for monobroadleaf wireless facilities as specified in the Wireless Master Plan (WMP). The monoeucalyptus height and design would be similar to the adjacent Verizon facility with branch limbs that extend out a minimum of 10 feet from the center with broad leaves that simulate a typical tree form. The equipment proposed for the tree includes four (4) six-foot panel antennas, two (2) air antennas, twenty-four (24) RRUs, three (3) surge suppression units, eight (8) DC power trunks (underground), and three (3) fiber trunks. To comply with the guidelines for the WMP, the facility is designed to accommodate a potential future co-location with the vertical extension of the monoeucalyptus. The applicant estimates a second carrier would result in a 20-foot height increase to accommodate the required spacing between equipment.

The project also includes a 280 (20 feet x 14 feet) square foot expansion to the existing Verizon ground-mounted equipment enclosure that is located adjacent to the water tower. The exterior walls would be eight feet tall and constructed with a split face CMU block wall

to match the existing enclosure. The proposed equipment includes one (1) DC power plant, two (2) Purcell cabinets, one (1) 20kw generator with a 105-gallon fuel tank, three (3) surge suppression units, two (2) fiber management boxes, one (1) telco box and ciena box, one (1) PTLC with ATS/MTS and Camlook, and a cable tray for the DC and fiber trunks (see Attachment 2).

Appendix B of the WMP specifies design criteria for Monobroadleaf (wireless facility disguised as a broadleaf tree) wireless facilities which are applicable to the project (Attachment 5).

The proposed wireless telecommunication facility is subject to the standards identified in Section 17.28.070 of the San Clemente Municipal Code (SCMC), which requires wireless projects on City property to obtain a CUP for new antennas on City property that are not in a pre-approved location designated in the Wireless Master Plan. To ensure compliance with the WMP, additional details and revisions should be incorporated into the design of the project which include the following: 1) branches should exceed all antennas by a minimum of 12 inches, 2) the foliage should be extruded in color, 3) there should be a minimum space of five feet between the top of the antenna and the top of the faux tree, and 4) all antennas should be covered with "leafed antenna socks" to match the foliage color. While the WMP calls for branches to start 15-feet above the ground it would increase the height of the facility by 10-feet and would be taller than the Verizon monoeucalyptus facility. The applicant is supportive of the revisions to the project to be consistent with the WMP but notes that maintaining a minimum of five-feet between the top of the antenna and the tree would increase the faux tree height from 20 feet to 22 feet.

REVIEWING AUTHORITY:

Under SCMC 17.16.060, Design Review Subcommittee (DRSC) is required for new antenna projects (Table 17.12.025 – Applications and Design Review Process). Under SCMC 17.12.020, the Planning Commission is the review authority for a CUP for a new wireless telecommunication facility.


RECOMMENDATION:

Staff seeks a recommendation from the DRSC for the wireless facility's design to provide to the Planning Commission.

Attachments:

- 1. Location Map
- 2. Conceptual Project Plans
- 3. Site Photos
- 4. Photo Simulations
- 5. Wireless Master Plan Excerpt

City of San Clemente Community Map **ATTACHMENT 1**

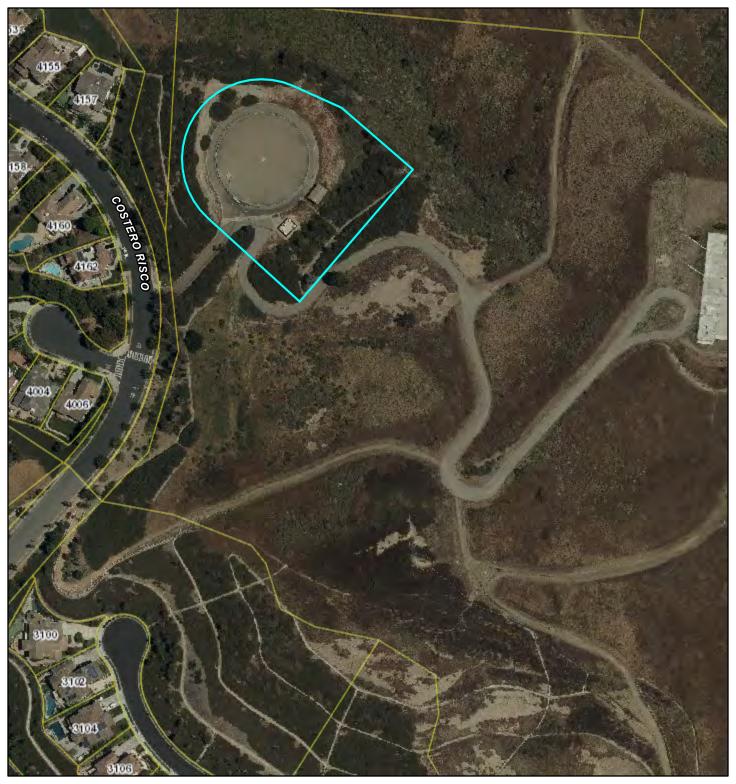

9/20/2023, 9:32:19 PM 1:2,257 0.01 0.03 Eagle 1ft Tiled 2019 Parcel Labels 0.05 0.03 Red: Band_1 **Parcels** Green: Band_2 World Boundaries and Places Eagle Aerial Blue: Band_3 City Boundary

0.06 mi

0.1 km

ATTACHMENT 2



SITE NUMBER: CLL01419 SITE NAME: AVENIDA CA

> **4159 COSTERO RISCO SAN CLEMENTE, CA 92673**

ATC SITE NUMBER: 420172

PACE #: MRLOS075202, USID: 307200, CASPR #: 3551A0WASX, FA #: 13023946

SITE INFORMATION

SAN CLEMENTE, CA 92673

APPLICANT ADDRESS

AT&T MOBILITY 1452 EDINGER AVE. TUSTIN, CA 92780

APPLICANT REPRESENTATIVE: ADDRESS:

SMARTLINK 1997 ANNAPOLIS EXCHANGE PKWY., SUITE 200 ANNAPOLIS, MD 21401

LATITUDE (NAD 83): N 33' 27' 53.01" N (33.464725') LONGITUDE(NAD 83): W 117' 36' 59.77" W (-117.616603')

GROUND ELEVATION: 626.19' AMSL

OCCUPANCY:

679-242-05

ZONING JURISIDICTION: CITY OF SAN CLEMENTE

CURRENT ZONING: FORSTERS RANCH SPECIFIC PLAN PROPOSED USE: UNMANNED TELECOMMUNICATIONS FACILITY

LEASE SPACE:

PROJECT TEAM

PROJECT MANAGER: SMARTLINK

CONTACT: MOISES ACEVES PHONE: (760) 799-6670

LAND USE PLANNER: SMARTLINK CONTACT: CHRIS DOHENY

PHONE: (619) 944-8528 EMAIL: chris.doheny@smartlin

CONSTRUCTION MANAGER: AT&T MOBILITY SERVICES LLC CONTACT: ANDRE CAMOU PHONE: (562) 293-6236

A/E MANAGER: CELLSITE CONCEPTS 16885 VIA DEL CAMPO CT., SUITE 318 SAN DIEGO, CA 92127 CONTACT: SEV FRANCISCO PHONE: (858) 432-4112 EMAIL: sfrancisco@cellsite

SITE ACQUISITION: SMARTLINK CONTACT: ERIK HARGRAVE PHONE: (626)-695-7375

DO NOT SCALE **DRAWINGS**


SUBCONTRACTOR SHALL VERIFY ALL PLANS, EXISTING DIMENSIONS & FIELD CONDITIONS ON THE JOB SITE & SHALL IMMEDIATELY NOTIFY THE ENGINEER IN WRITING OF ANY DISCREPANCIES BEFORE PROCEEDING WITH THE WORK OR BE RESPONSIBLE FOR SAME.



811 / 800-227-2600 digalert.org

THE FACILITY IS UNMANNED AND NOT FOR HUMAN HABITATION. HANDICAPPED ACCESS OTABLE WATER, OR TRASH DISPOSAL IS REQUIRED AND NO COMMERCIAL SIGNAGE IS NEW.

LOCATION MAPS

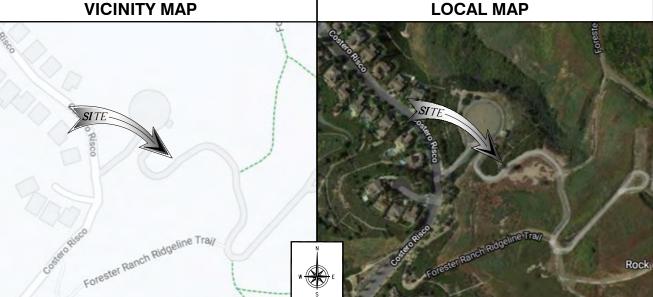

DRIVING DIRECTIONS

DIRECTION FROM AT&T OFFICE (1452 EDINGER AVE., TUSTIN, CA 92780):

- START OUT GOING SOUTHEAST ON EDINGER AVENUE TOWARD RED HILL AVENUE TURN LEFT ONTO RED HILL AVENUE MERGE ONTO 1-5 S TOWARD SAN DIEGO TAKE THE AVE VISTA HERMOSA EXIT, EXIT 77. TURN LEFT ONTO AVENIDA VISTA HERMOSA TURN LEFT ONTO CAMINO VERA CRUZ TURN RICHT ONTO COSTERO RISCO 4159 COSTERO RISCO, SAN CLEMENTE CA 92673-6408 IS ON THE RIGHT

GENERAL NOTES

HE FACILITY IS OMMINICED AND NOT FOR HOMAIN PARTIATION. HAVIOLAFFEL ACCESS EQUIREMENTS ARE NOT REQUIRED IN ACCORDANCE WITH THE 2022 CALIFORNIA BUILDING CODE. A CHINICIAN WILL VISIT THE SITE AS REQUIRED FOR ROUTINE MAINTENANCE. THE PROJECT WILL NOT ESULT IN ANY SIGNIFICANT DISTURBANCE OR EFFECT ON DRAINAGE: NO SANITARY SEWER SERVICE.

CODE COMPLIANCE

ALL WORK AND MATERIALS SHALL BE PERFORMED AND INSTALLED IN ACCORDANCE WITH THE CURRENT EDITIONS OF THE FOLLOWING CODES AS ADOPTED BY THE LOCAL GOVERNING AUTHORITIES.

- CALIFORNIA ADMINISTRATIVE CODE (INCL TITLE 24 & 25)
- CALIFORNIA ADMINISTRATUS CODE (INC. 2022 CALIFORNIA BUILDING CODE 2022 CALIFORNIA MECHANICAL CODE 2022 CALIFORNIA ELECTRICAL CODE 2022 CALIFORNIA ELECTRICAL CODE 2022 CALIFORNIA FIRE CODE 2022 CALIFORNIA FIRE CODE 2022 L

- BUILDING OFFICIALS & CODE ADMINISTRATORS (BOCA)
 CITY/COUNTY ORDINANCES
- ANSI/TIA-222-H
 LIFE SAFETY CODE NFPA-101

THE TELECOMMUNICATIONS EQUIPMENT SPACE SHOWN ON THESE PLANS IS NOT CUSTOMARILY OCCUPIED. WORK TO BE PERFORMED IN THIS FACILITY CANNOT REASONABLY BE PERFORMED BY PERSONS WITH A SEVERE IMPAIRMENT: MOBILITY, SIGHT, AND/OR HEARING. THEREFORE, PER 2022 CALIFORNIA BUILDING CODE SECTION 1105B.3.4, AND/OR 11B-203.5 OF 2022 CALIFORNIA BUILDING CODE, EXCEPTION 1, THIS FACILITY SHALL BE EXEMPTED FROM ALL TITLE 24 ACCESS REQUIREMENTS

ACCESSIBILITY NOTE

PROJECT DESCRIPTION

AT&T MOBILITY PROPOSES TO CONSTRUCT AN UNMANNED WIRELESS COMMUNICATION FACILITY. THE SCOPE WILL CONSIST OF THE

ANTENNA LEVEL

- PROPOSED (1) 20' HIGH MONOEUCALYPTUS.
 PROPOSED (4) 6' PANEL ANTENNAS ON PROPOSED MONOEUCALYPTUS. (2 PER SECTOR)
- PROPOSED (2) AIR 6449 N77 ANTENNA ON PROPOSED MONOEUCALYPTUS. (1 PER SECTOR)
 PROPOSED (24) RRUS MOUNTED BEHIND PANEL ANTENNAS ON PROPOSED MONOEUCALYPTUS. (12 PER SECTOR)
- PROPOSED (3) DC9 SURGE SUPPRESSION UNITS ON MOUNTED ON PROPOSED ANTENNA MOUNTING FRAME.
- PROPOSED (8) DC POWER TRUNKS ROUTED INSIDE PROPOSED MONOEUCALYPTUS. PROPOSED (3) FIBER TRUNKS ROUTED INSIDE PROPOSED MONOEUCALYPTUS.

- PROPOSED (1) DC POWER PLANT MOUNTED ON CONCRETE PAD INSIDE PROPOSED CMU WALL ENCLOSURE.
 PROPOSED (2) PURCELL CABINETS (STACKED) MOUNTED ON CONCRETE PAD INSIDE PROPOSED CMU WALL ENCLOSURE.
- PROPOSED (1) 20kW AC GENERAC GENERATOR WITH 97 GALLON FUEL TANK MOUNTED ON CONCRETE PAD INSIDE PROPOSED
- CMU WALL ENCLOSURE.

 PROPOSED (3) DC12 SURGE SUPPRESSION UNITS MOUNTED INSIDE PROPOSED CMU WALL ENCLOSURE
- PROPOSED (2) FIBER MANAGEMENT BOXES MOUNTED INSIDE PROPOSED CMU WALL ENCLOSURE.
- PROPOSED (1) TELCO BOX AND CIENA BOX MOUNTED INSIDE PROPOSED CMU WALL ENCLOSURE.
 PROPOSED (1) PTLC WITH ATS/MTS AND CAMLOK MOUNTED INSIDE PROPOSED CMU WALL ENCLOSURE.
- PROPOSED CABLE TRAY FOR DC AND FIBER TRUNKS.
 PROPOSED SPLITFACE CMU WALL ENCLOSURE TO MATCH EXISTING.

DRAWING INDEX

SHEET NO:	SHEET TITLE
T-1	TITLE SHEET
LS-1	TOPOGRAPHIC SURVEY
LS-2	TOPOGRAPHIC SURVEY
A-1	SITE PLAN
A-2	EQUIPMENT LAYOUT AND ANTENNA PLAN
A-3	ELEVATIONS
A-4	ELEVATIONS

SIGNATURE BLOCK

	PRINT NAME	SIGNATURE	DATE
AT&T RF:			
AT&T PM:			
AT&T CM:			
SMARTLINK PM:			
SMARTLINK ZM:			
SMARTLINK SAQ:			
SMARTLINK CM:			







SAN DIEGO, CA 92127 tel: (858) 432-4112 / (858) 432-4257

1			
4	1	03/30/2023	SMARTLINK COMMENTS
	0	07/07/2021	100% ZD SET
	A	05/19/2021	90% ZD's FOR REVIEW

REV DATE ISSUED-DATE:

03/30/2023

DESCRIPTION

100% ZD SET


ı	LICENSURE

CLL01419 AVENIDA CA 4159 COSTERO RISCO SAN CLEMENTE, CA 92673

DRAWN BY:		
CHECKED BY:	SVF	

TITLE SHEET

T-1

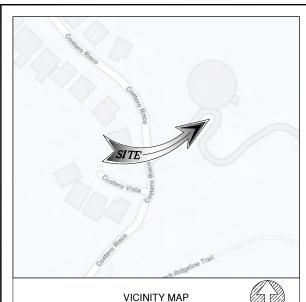

APN 679-242-05

SITE ADDRESS 4159 COSTERO RISCO, SAN CLEMENTE, CA 92673

TITLE REPORT

TITLE REPORT WAS PREPARED BY COMMONWEALTH LAND TITLE INSURANCE COMPANY WITH ORDER NUMBER 92016113-920-CMM-CM8 AND GUARANTEE NUMBER CA-SFXFC-IMP-81G28-2-21-92016113 DATED OCTOBER 19, 2021.

BASIS OF BEARING

BEARINGS SHOWN HEREON ARE BASED UPON U.S. STATE PLANE NAD83 COORDINATE SYSTEM CALIFORNIA STATE PLANE COORDINATE ZONE SIX, DETERMINED BY GPS OBSERVATIONS.

BENCHMARK

ELEVATIONS ARE BASED ON CRTN (CSRC) NETWORK BROADCAST COORDINATES.

FLOODZONE

SITE IS LOCATED IN FLOOD ZONE "X" AS PER F.I.R.M. MAP NO. 06059C0528J EFFECTIVE DATE 12/03/2009.

NOTES:

1. THIS IS NOT A BOUNDARY SURVEY. THIS IS A SPECIALIZED TOPOGRAPHIC MAP. THE PROPERTY LINES AND EASEMENTS SHOWN HEREON ARE FROM RECORD INFORMATION AS NOTED HEREON. CELLSITE CONCEPTS TRANSLATED THE TOPOGRAPHIC SURVEY TO RECORD INFORMATION USING FOUND MONUMENTS SHOWN HEREON. THE LOCATION OF PROPERTY LINES SHOWN HEREON ARE APPROXIMATE AND FOR INFORMATIONAL PURPOSES ONLY. THEY ARE NOT TO BE RELIED UPON AS THE ACTUAL BOUNDARY LINES.

- ANY CHANGES MADE TO THE INFORMATION ON THIS PLAN, WITHOUT THE WRITTEN CONSENT OF CELLSITE CONCEPTS, RELIEVES CELLSITE CONCEPTS OF ANY AND ALL LIABILITY.
- THE HEIGHTS AND ELEVATIONS FOR THE TREES, BUSHES AND OTHER LIVING PLANTS SHOWN HEREON, SHOULD BE CONSIDERED APPROXIMATE (+/-) AND ONLY FOR THE DATE OF THIS SURVEY. THEY ARE PROVIDED AS A GENERAL REFERENCE AND SHOULD NOT BE USED FOR DESIGN PURPOSES.
- 4. WRITTEN DIMENSIONS SHALL TAKE PREFERENCE OVER SCALED & SHALL BE VERIFIED ON THE JOB SITE. ANY DISCREPANCY SHALL BE BROUGHT TO THE NOTICE OF THE SURVEYOR PRIOR TO COMMENCEMENT OF ANY WORK.
- 5. FIELD SURVEY COMPLETED ON MAY 05, 2021

LEGAL DESCRIPTION

ALL THAT CERTAIN REAL PROPERTY SITUATED IN THE CITY OF SAN CLEMENTE, COUNTY OF ORANGE, STATE OF CALIFORNIA, DESCRIBED AS FOLLOWS:

PARCEI

THOSE PORTIONS OF THE RANCHO BOCA DE LA PLAYA, AS SHOWN ON A MAP RECORDED JUNE 29, 1887, IN BOOK 4, PAGES 118 AND 119 OF PATENTS, RECORDS OF LOS ANGELES COUNTY, CALIFORNIA, AND OF SECTION 21, TOWNSHIP 8 SOUTH, RANGE 7 WEST, SAN BERNARDINO MERIDIAN, ACCORDING TO THE OFFICIAL PLAT THEREOF FILED IN THE DISTRICT LAND OFFICE SEPTEMBER 17, 1887, ALL BEING IN THE CITY OF SAN CLEMENTE, COUNTY OF ORANGE, STATE OF CALIFORNIA, MORE PARTICULARLY DESCRIBED AS FOLLOWS:

BEGINNING AT THE INTERSECTION OF THE NORTHEASTERLY TERMINUS OF THE CENTERLINE OF CAMINO VERA CRUZ AND THE NORTHEASTERLY TRACT BOUNDARY, ALL AS SHOWN ON THE MAP OF TRACT NO. 10417, RECORDED IN BOOK 523, PAGES 1 THROUGH 6, INCLUSIVE, OF MISCELLANEOUS MAPS, RECORDS OF ORANGE COUNTY; THENCE NORTH 50' 39' 17" EAST 459,22 FEET TO THE POINT OF BEGINNING; THENCE NORTH 47' 04' 45" WEST 202.18 FEET TO A TANGENT CURVE, CONCAVE SOUTHEASTERLY, WITH A RADIUS OF 130.00 FEET; THENCE NORTHWESTERLY, NORTHERLY, NORTHEASTERLY, AND EASTERLY ALONG SAID CURVE THROUGH A CENTRAL ANGLE OF 162' 04' 45", AN ARC DISTANCE OF 367.75 FEET; THENCE SOUTH 65' 00' 00" EAST 85.50 FEET; THENCE SOUTH 48' 28' 04" EAST 154.00 FEET; THENCE SOUTH 41' 31' 56" WEST 283.82 FEET TO THE TRUE POINT OF BEGINNING.

PARCEL

A NON-EXCLUSIVE EASEMENT FOR THE PURPOSE OF PEDESTRIAN AND VEHICULAR INGRESS AND EGRESS AND UTILITY PURPOSES UPON, OVER AND THROUGH THOSE PORTIONS OF THE RANCHO BOCA LA PLAYA, AS SHOWN ON A MAP RECORDED JUNE 29, 1887, IN BOOK 4, PAGES 118 AND 119 OF PATENTS, RECORDS, OF LOS ANGELES COUNTY, CALIFORNIA, AND OF SECTION 21, TOWNSHIP 8 SOUTH, RANGE 7 WEST, SAN BERNARDINO MERIDIAN, ACCORDING TO THE OFFICIAL PLAT THEREOF FILED IN THE

DISTRICT LAND OFFICE SEPTEMBER 17, 1887, ALL BEING IN THE CITY OF SAN CLEMENTE, COUNTY OF ORANGE, STATE OF CALIFORNIA, MORE PARTICULARLY DESCRIBED AS

BEGINNING AT THE INTERSECTION OF THE NORTHEASTERLY TERMINUS OF THE CENTERLINE OF CAMINO VERA CRUZ AND THE NORTHEASTERLY TRACT BOUNDARY, ALL AS SHOWN ON THE MAP OF TRACT NO. 10417, RECORDED IN BOOK 523, PAGES" 1' THROUGH 6, INCLUSIVE, OF MISCELLANEOUS MAPS, RECORDS OF ORANGE COUNTY; THENCE ALONG SAID; NORTHEASTERLY TRACT BOUNDARY, NORTH 42' 22' 55" WEST 38.55 FEET TO THE POINT OF BEGINNING; THENCE NORTH: 41' 43" 19" EAST 154.87 FEET TO THE BEGINNING OF A 25.00 FOOT RADIUS TANGENT CURVE, CONCAVE WESTERLY; THENCE NORTHEASTERLY AND NORTHERLY ALONG SAID CURVE THROUGH A CENTRAL ANGIE OF

ANGLE OF 47" AN ARC LENGTH OF 18.06 FEET; THENCE NORTH 00: 19' 32" EAST 113.95 FEET; THENCE NORTH 88' 40' 28" WEST 2.00 FEET TO THE BEGINNING OF A 47.00 FOOT RADIUS NON-TANGENT CURVE, CONCAVE SOUTHEASTERLY, A RADIAL THROUGH SAID POINT BEARS NORTH 89' 40' 28" WEST; THENCE NORTHERLY AND NORTHEASTERLY ALONG SAID CURVE THROUGH A CENTRAL ANGLE OF 86' 05' 52" AN ARC LENGTH OF 70.63 FEET; THENCE NORTH 86' 25' 24" EAST 1.0.01 FEET TO THE BEGINNING OF A 23.00 FOOT RADIUS TANGENT CURVE, CONCAVE NORTHWESTERLY; THENCE EASTERLY AND NORTHEASTERLY ALONG SAID CURVE THROUGH A CENTRAL ANGLE OF 45' 00' 00" AN

ARC LENGTH OF 18.06 FEET; THENCE NORTH 41' 25' 24" EAST 91.17 FEET TO THE BEGINNING OF A58.00 FOOT RADIUS TANGENT CURVE, CONCAVE NORTHWESTERLY; THENCE NORTHEASTERLY ALONG SAID CURVE THROUGH A CENTRAL ANGLE OF 19' 20' 46" AN ARC LENGTH OF 19.58 FEET; THENCE SOUTH 47' 04' 45" EAST 35.29 FEET; THENCE SOUTH 47' 25' 24" WEST 149.21 FEET; THENCE SOUTH 86' 25' 24" WEST 35.62 FEET; THENCE SOUTH OF 32" WEST 121.59 FEET; THENCE SOUTH 41' 23' 47" WEST 189.06 FEET TO A POINT ON THE SAID NORTHEASTERLY BOUNDARY, THENCE NORTHWESTERLY ALONG SAID TRACT BOUNDARY NORTH 42' 22' 55" WEST 20.11 FEET TO THE POINT OF BEGINNING.

APN: 679-242-05

SCHEDULE B (EXCEPTIONS)


PROPERTY LINES DERIVED FROM: TRACT MAP NO. 15562 TRACT MAP NO. 15718

ASSESSOR'S MAP NO. 678-15 DATED 2005

TRACT MAP NO. 16040 PARCEL MAP NO. 98-170

ITEM A IS TAX RELATED ITEM B IS LIEN RELATED

ITEM 1 IS AGREEMENT RELATED

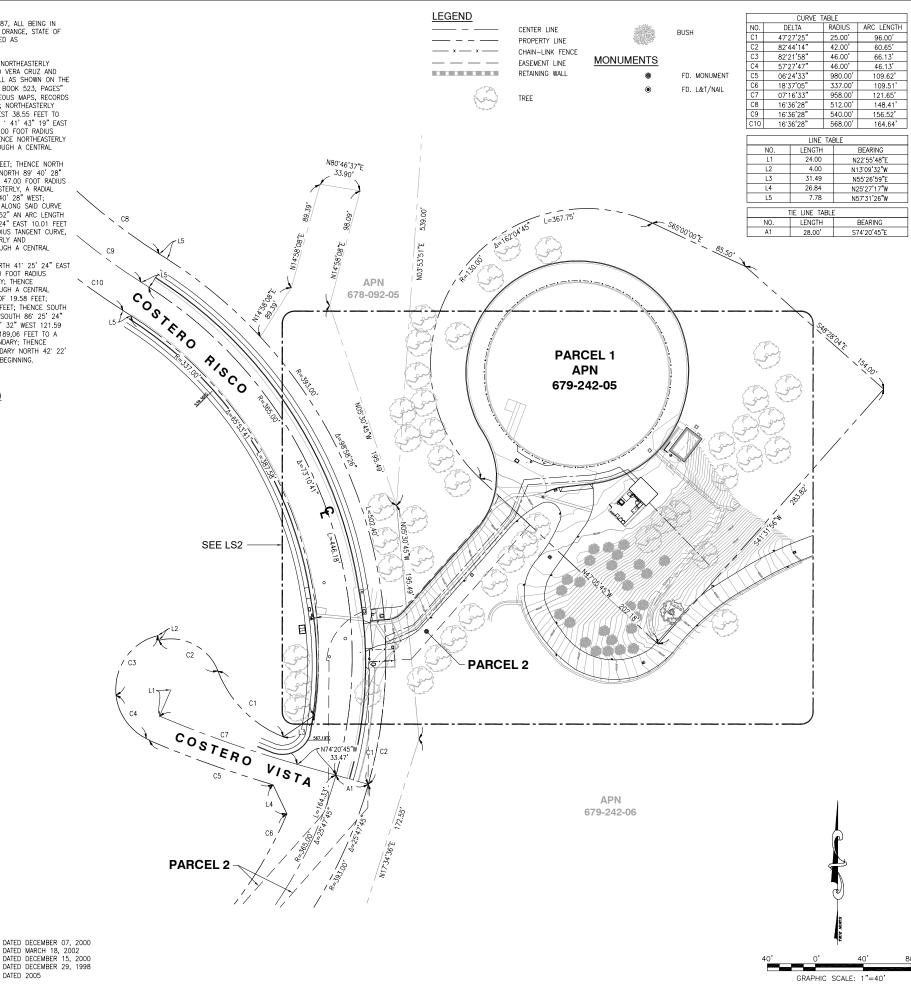






1997 ANNAPOLIS EXCHANGE PKWY., SUITE 200 ANNAPOLIS, MD 21401



10650 SCRIPPS RANCH BLVD., SUITE 224 SAN DIEGO, CA 92131 tel: (858) 433-7173 / (858) 433-7176

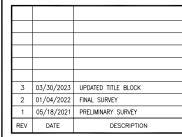

ISSUED-DATE:

MARCH 30, 2023

ISSUED FOR: -

FINAL SURVEY

LAND SUPERIOR LAND SUPERIOR L.S. 8780 **

L.S. 8780 **

L.S. 12/31/22 **

1/4/22 **

OF CALL

PROJECT-INFORMATION:

CLL01419

AVENIDA

4159 COSTERO RISCO,
SAN CLEMENTE, CA 92673

DRAWN BY: JDC
CHECKED BY: RH

SHEET-TITLE:

TOPOGRAPHIC SURVEY

SHEET-NUMBER:

LS-1

12 FEET WIDE AT&T NON-EXCLUSIVE INGRESS/EGRESS ROUTE CENTERLINE DESCRIPTION:

THOSE PORTIONS OF THE RANCHO BOCA DE LA PLAYA, AS SHOWN ON A MAP THOSE PORTIONS OF THE RANCHO BOCA DE LA PLAYA, AS SHOWN ON A MAP RECORDED JUNE 29, 1887, IN BOOK 4, PAGES 118 AND 119 OF PATENTS, RECORDS OF LOS ANGELES COUNTY, CALIFORNIA, AND OF SECTION 21, TOWNSHIP 8 SOUTH, RANGE 7 WEST, SAN BERNARDINO MERIDIAN, ACCORDING TO THE OFFICIAL PLAT THEREOF FILED IN THE DISTRICT LAND OFFICE SEPTEMBER 17, 1887, ALL BEING IN THE CITY OF SAN CLEMENTE, COUNTY OF ORANGE,

A STRIP OF LAND FOR THE PURPOSES OF ACCESS EASEMENT FOR THE LAND REFERRED TO HEREIN SITUATED IN THE CITY OF SAN CLEMENTE, IN THE COUNTY OF ORANGE, STATE OF CALIFORNIA, AND IS DESCRIBED AS FOLLOWS:

AN ACCESS EASEMENT BEING TWELVE (12.00) FEET IN WIDTH AND LYING SIX (6.00) FEET ON EACH SIDE OF THE FOLLOWING DESCRIBED CENTERLINE:

COMMENCING AT THE INTERSECTION OF THE CENTERLINE OF COSTERO RISCO AND THE CENTERLINE OF COSTERO VISTA, ALL AS SHOWN ON THE MAP OF TRACT NO. 15562, RECORDED IN BOOK 810, PAGES 14 THROUGH 18, INCLUSIVE, OF MISCELLANEOUS MAPS, RECORDS OF ORANGE COUNTY; THENCE SOUTH 74:20'45" FAST A DISTANCE OF 28:00 FFFT TO THE FASTERLY RIGHT OF WAY OF COSTERO RISCO; THENCE NORTHWESTERLY ALONG SAID RIGHT OF WAY, WITH A RADIUS OF 393.00 FEET THROUGH A CENTRAL ANGLE OF 18'08'01", AN ARC DISTANCE OF 124.38 FEET TO THE TRUE POINT OF BEGINNING:

THENCE NORTH 67'06'56" EAST A DISTANCE OF 25.39 FEET; THENCE NORTH 4119'30" EAST A DISTANCE OF 121.75 FEET; THENCE NORTH 21'51'52" EAST A DISTANCE OF 31.79 FEET; THENCE NORTH 86'00'36" EAST A DISTANCE OF 56.34 FEET; THENCE NORTH 78:05'31" EAST A DISTANCE OF 14.82 FEET: THENCE NORTH 67:53'11" EAST A DISTANCE OF 9.49 FEET; THENCE SOUTH 45'31'32" FAST A DISTANCE OF 18.57 FEFT TO THE PROPOSED. AT&T LEASE AREA BEING POINT "A" AND ALSO BEING THE POINT OF TERMINUS.

THE SIDE LINES OF SAID EASEMENT TO BE PROLONGED OR SHORTENED TO MEET AT ANGLE-POINT INTERSECTIONS.

3 FEET WIDE AT&T NON-EXCLUSIVE UTILITY ROUTE CENTERLINE DESCRIPTION:

THOSE PORTIONS OF THE RANCHO BOCA DE LA PLAYA, AS SHOWN ON A MAP RECORDED JUNE 29, 1887, IN BOOK 4, PAGES 118 AND 119 OF PATENTS, RECORDS OF LOS ANGELES COUNTY, CALIFORNIA, AND OF SECTION 21, TOWNSHIP 8 SOUTH, RANGE 7 WEST, SAN BERNARDINO MERIDIAN, ACCORDING TO THE OFFICIAL PLAT THEREOF FILED IN THE DISTRICT LAND OFFICE SEPTEMBER 17, 1887 AND A THE OFFICE OF CAN ELECTRICATE COUNTY OF CONTROL OF THE OFFICE SEPTEMBER 17, 1887 AND A THE OFFICE OF CAN ELECTRICATE COUNTY OF CONTROL OF CONTROL OF CAN ELECTRICATE COUNTY OF CONTROL OF CAN ELECTRICATE COUNTY OF CONTROL OF CAN ELECTRICATE COUNTY OF CONTROL OF CONTROL OF CAN ELECTRICATE COUNTY OF CONTROL OF CONTROL OF CONTROL OF COUNTY OF CONTROL OF 17, 1887, ALL BEING IN THE CITY OF SAN CLEMENTE, COUNTY OF ORANGE, STATE OF CALIFORNIA

A STRIP OF LAND FOR THE PURPOSES OF UTILITY EASEMENT FOR THE LAND REFERRED TO HEREIN SITUATED IN THE CITY OF SAN CLEMENTE, IN THE COUNTY OF ORANGE, STATE OF CALIFORNIA, AND IS DESCRIBED AS FOLLOWS:

AN LITHITY FASEMENT BEING THREE (3.00) FEET IN WIDTH AND LYING FIGHTEEN (18.00) INCHES ON EACH SIDE OF THE FOLLOWING DESCRIBED CENTERLINE:

COMMENCING AT THE INTERSECTION OF THE CENTERLINE OF COSTERO RISCO AND THE CENTERLINE OF COSTERO VISTA, ALL AS SHOWN ON THE MAP OF TRACT NO. 15562, RECORDED IN BOOK 810, PAGES 14 THROUGH 18, INCLUSIVE OF MISCELLANEOUS MAPS RECORDS OF ORANGE COUNTY THENCE SOUTH 74'20'45" EAST A DISTANCE OF 28.00 FEET TO THE EASTERLY RIGHT OF WAY OF COSTERO RISCO; THENCE NORTHWESTERLY ALONG SAID RIGHT OF WAY, WITH A RADIUS OF 393.00 FEET THROUGH A CENTRAL ANGLE OF 17:25'55", AN ARC DISTANCE OF 119.57 FEET TO THE TRUE POINT OF BEGINNING:

THENCE NORTH 67'06'56" EAST A DISTANCE OF 28.12 FEET; THENCE NORTH 41'19'30" FAST A DISTANCE OF 123.55 FFFT: THENCE NORTH 21'51'52" EAST A DISTANCE OF 29.74 FEET; THENCE NORTH 86'00'36" EAST A DISTANCE OF 53.83 FEET: THENCE NORTH 78'05'31" EAST A DISTANCE OF 15.54 FEET;
THENCE NORTH 67'53'11" EAST A DISTANCE OF 15.54 FEET; THENCE SOUTH 45'31'32" EAST A DISTANCE OF 12.20 FEET TO THE PROPOSED AT&T LEASE AREA BEING THE POINT OF TERMINUS.

THE SIDE LINES OF SAID EASEMENT TO BE PROLONGED OR SHORTENED TO MEET AT ANGLE—POINT INTERSECTIONS.

PROPOSED AT&T LEASE SPACE DESCRIPTION BEGINNING AT SAID POINT "A". THENCE NORTH 44'28'28" EAST A DISTANCE OF 6.46 FEET; THENCE SOUTH 45'31'32" EAST A DISTANCE OF 20.00 FEET; THENCE SOUTH 44'28'28" WEST A DISTANCE OF 10.29 FEET TO A POINT HEREIN REFERRED TO AS POINT "B" THENCE SOUTH 44'28'28" WEST A DISTANCE OF 3.71 FEET; THENCE NORTH 45'31'32" WEST A DISTANCE OF 20.00 FEET; THENCE NORTH 44'28'28" EAST A DISTANCE OF 7.54 FEET TO THE POINT OF BEGINNING OF THE PROPOSED AT&T LEASE AREA

CONTAINING 280 SQUARE FEET MORE OR LESS.

ADD'L 3 FEET WIDE AT&T NON-EXCLUSIVE CABLE ROUTE CENTERLINE DESCRIPTION:


THOSE PORTIONS OF THE RANCHO BOCA DE LA PLAYA, AS SHOWN ON A MAP RECORDED JUNE 29, 1887, IN BOOK 4, PAGES 118 AND 119 OF PATENTS, RECORDS OF LOS ANGELES COUNTY, CALIFORNIA, AND OF SECTION 21, TOWNSHIP 8 SOUTH, RANGE 7 WEST, SAN BERNARDINO MERIDIAN, ACCORDING TO THE OFFICIAL PLAT THEREOF FILED IN THE DISTRICT LAND OFFICE SEPTEMBER 17, 1887, ALL BEING IN THE CITY OF SAN CLEMENTE, COUNTY OF ORANGE, STATE OF CAUSEDING.

A STRIP OF LAND FOR THE PURPOSES OF UTILITY EASEMENT FOR THE LAND REFERRED TO HEREIN SITUATED IN THE CITY OF SAN CLEMENTE, IN THE COUNTY OF ORANGE, STATE OF CALIFORNIA, AND IS DESCRIBED AS FOLLOWS:

AN UTILITY EASEMENT BEING THREE (3.00) FEET IN WIDTH AND LYING EIGHTEEN (18.00) INCHES ON EACH SIDE OF THE FOLLOWING DESCRIBED CENTERLINE:

COMMENCING AT \underline{POINT} "B" THENCE SOUTH 43'52'59" EAST A DISTANCE OF 72.07 FEET TO THE PROPOSED AT&T MONOEUCALYPTUS BEING THE POINT OF TERMINUS.

THE SIDE LINES OF SAID EASEMENT TO BE PROLONGED OR SHORTENED TO MEET AT ANGLE-POINT INTERSECTIONS.

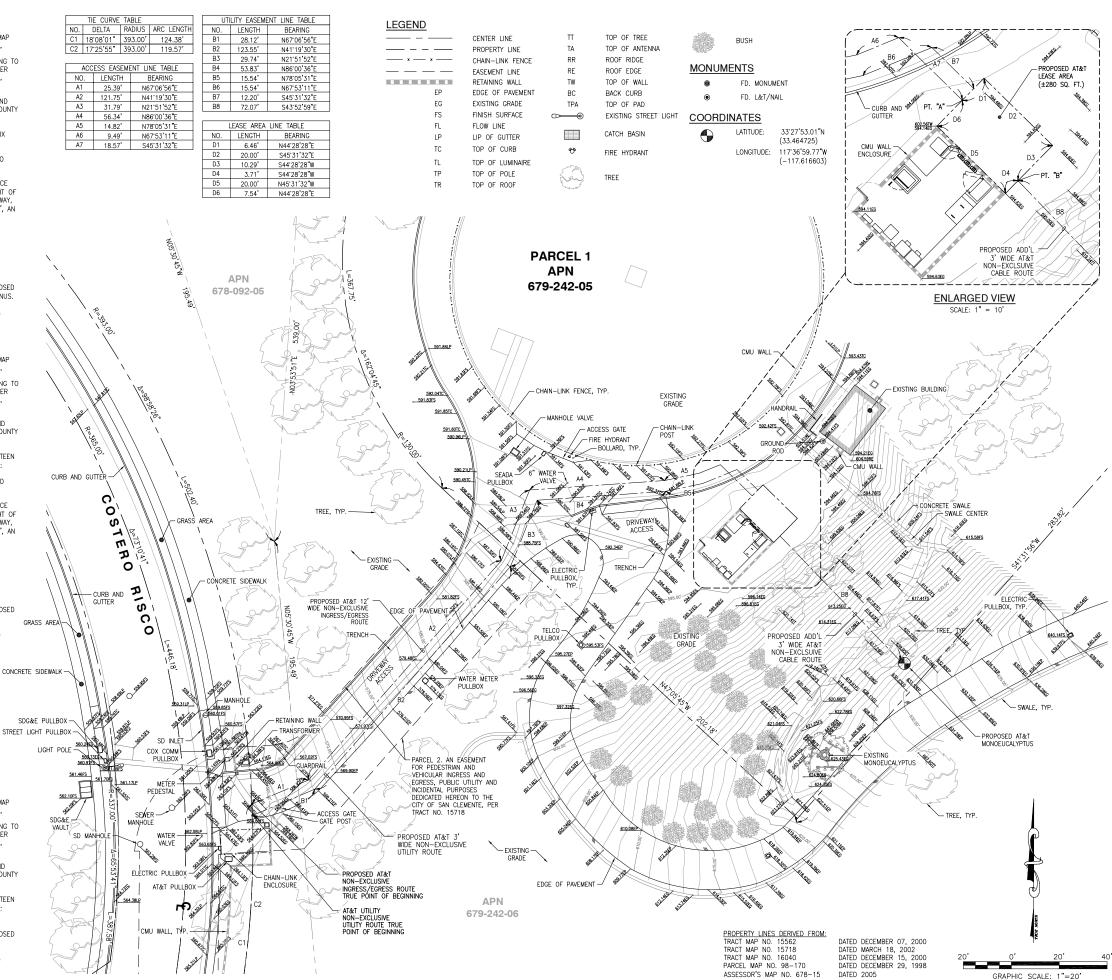





1997 ANNAPOLIS EXCHANGE PKWY., SUITE 200 ANNAPOLIS, MD 21401



SAN DIEGO, CA 92131 tel: (858) 433-7173 / (858) 433-7176

3	03/30/2023	UPDATED TITLE BLOCK
2	01/04/2022	FINAL SURVEY
1	05/18/2021	PRELIMINARY SURVEY
REV	DATE	DESCRIPTION

ISSUED-DATE:

MARCH 30, 2023

ISSUED FOR: -

FINAL SURVEY

LICENSURE:

PROJECT INFORMATION:

CLL01419 **AVENIDA** 4159 COSTERO RISCO, SAN CLEMENTE, CA 92673


DRAWN BY JDC

SHEET-TITLE:

TOPOGRAPHIC SURVEY

SHEET-NUMBER

LS-2

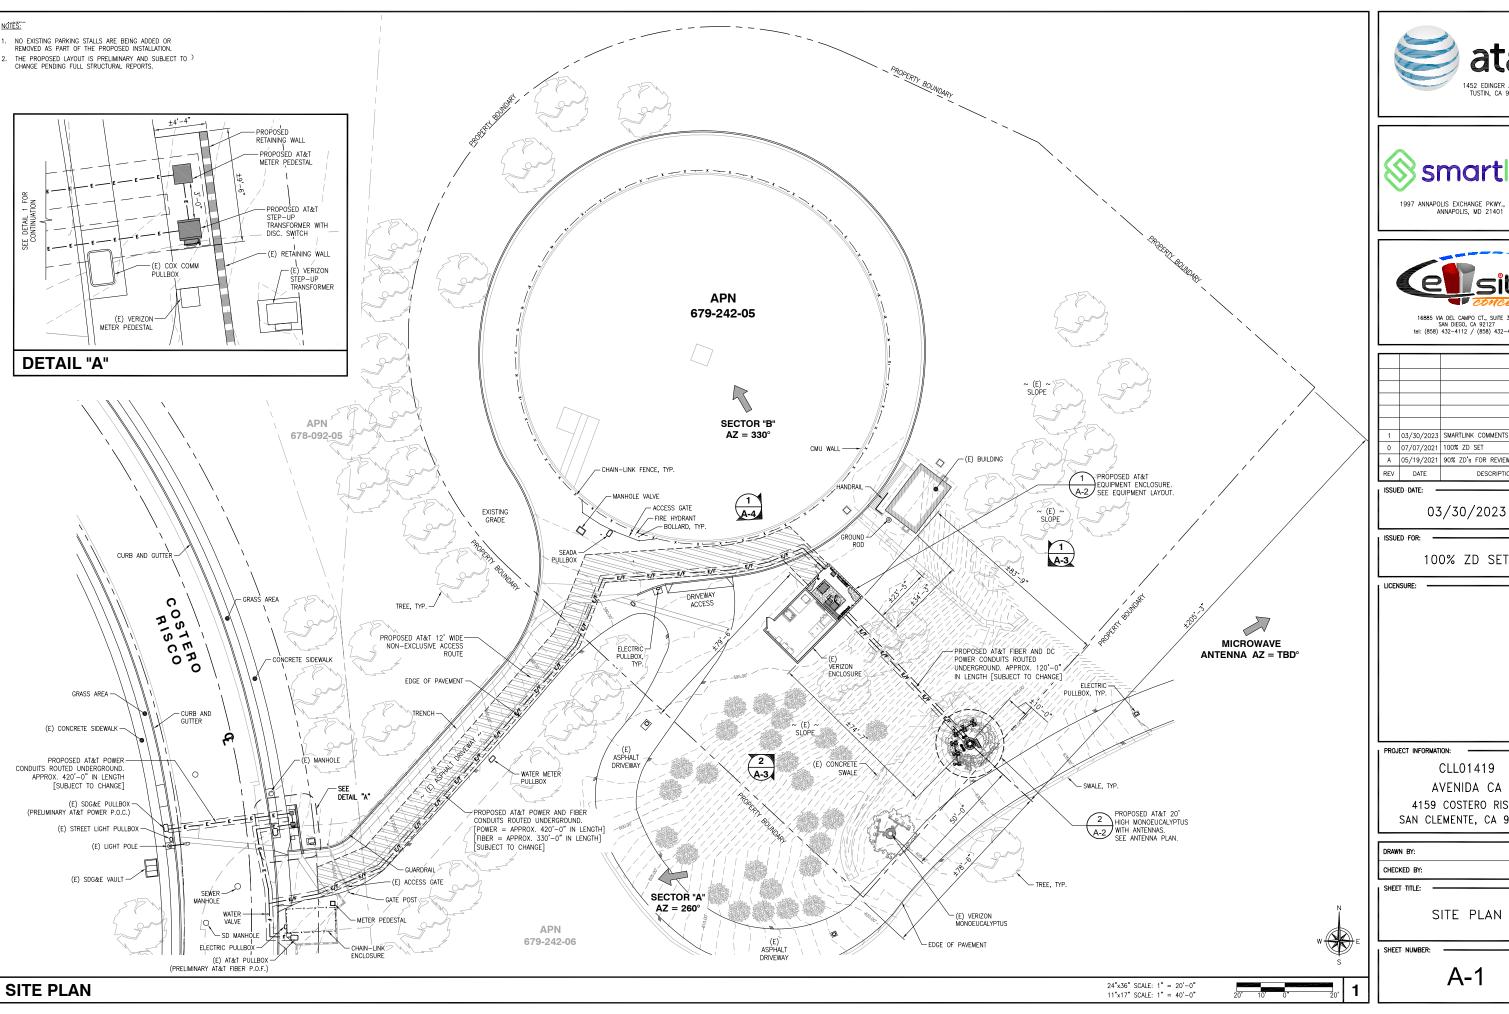








16885 VIA DEL CAMPO CT., SUITE 318 SAN DIEGO, CA 92127 tel: (858) 432-4112 / (858) 432-4257

ı			
Ш			
Ш			
Ш			
	1	03/30/2023	SMARTLINK COMMENTS
	0	07/07/2021	100% ZD SET
	Α	05/19/2021	90% ZD's FOR REVIEW
ı	REV	DATE	DESCRIPTION

AVENIDA CA 4159 COSTERO RISCO SAN CLEMENTE, CA 92673

CHECKED BY:	SVF
DRAWN BY:	

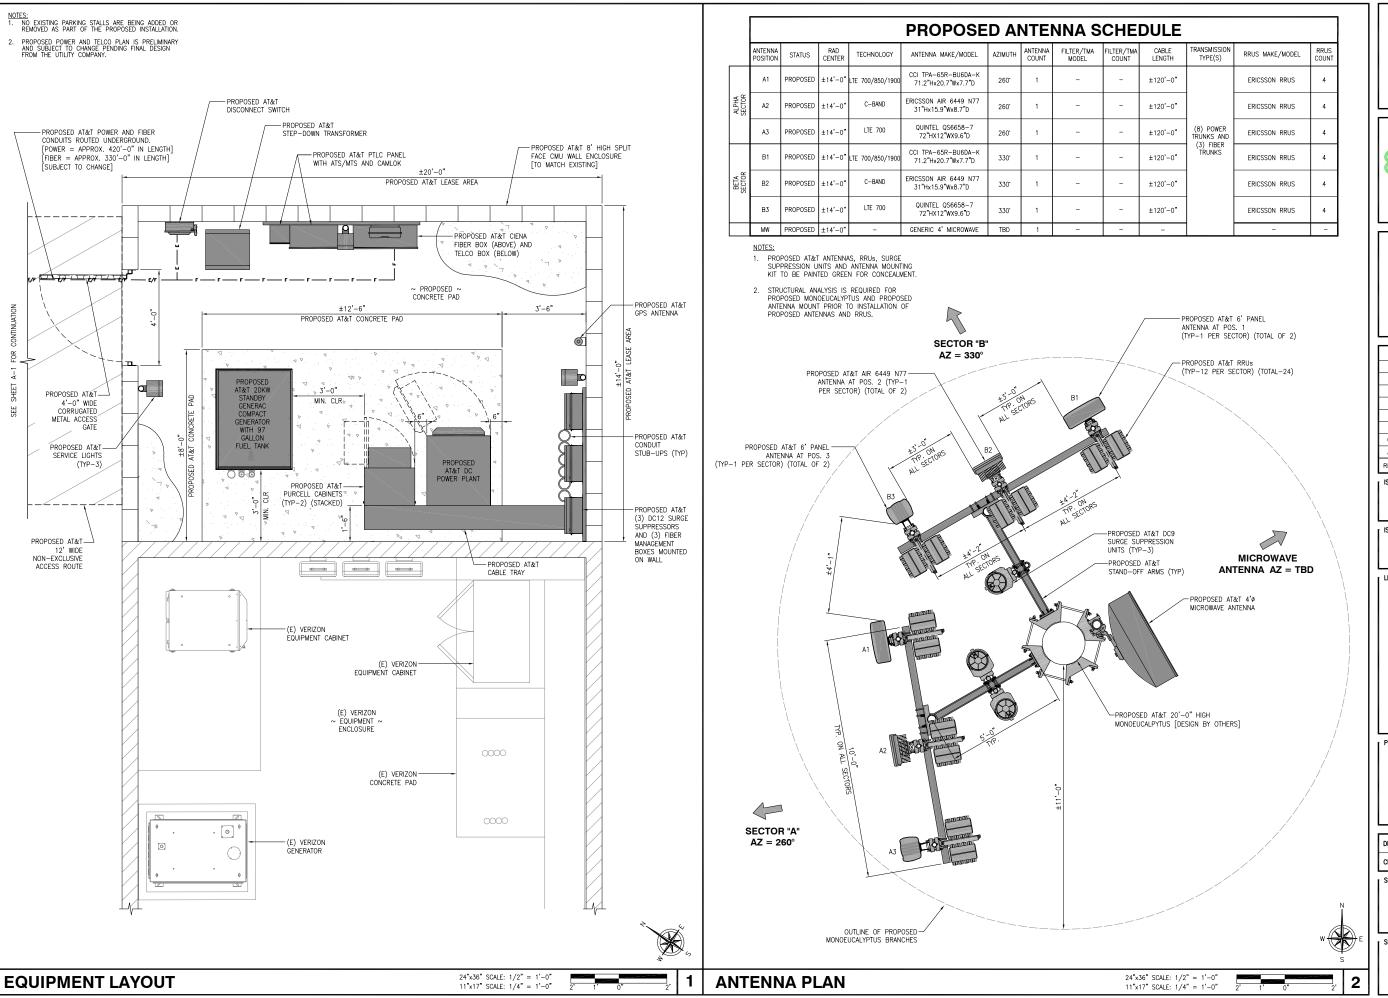





1997 ANNAPOLIS EXCHANGE PKWY., SUITE 200 ANNAPOLIS, MD 21401



16885 VIA DEL CAMPO CT., SUITE 318 SAN DIEGO, CA 92127 tel: (858) 432-4112 / (858) 432-4257

Ш			
П			
Ш			
Ш			
Ш			
П			
П	1	03/30/2023	SMARTLINK COMMENTS
П	0	07/07/2021	100% ZD SET
П	Α	05/19/2021	90% ZD's FOR REVIEW
П	REV	DATE	DESCRIPTION

ISSUED-DATE:

03/30/2023

I ISSUED FOR:

100% ZD SET

LICENSURE:

PROJECT INFORMATION:

CLL01419
AVENIDA CA
4159 COSTERO RISCO
SAN CLEMENTE, CA 92673


DRAWN BY:	JDC
CHECKED BY:	SVF

SHEET TITLE:

EQUIPMENT LAYOUT AND ANTENNA PLAN

SHEET NUMBE

A-2

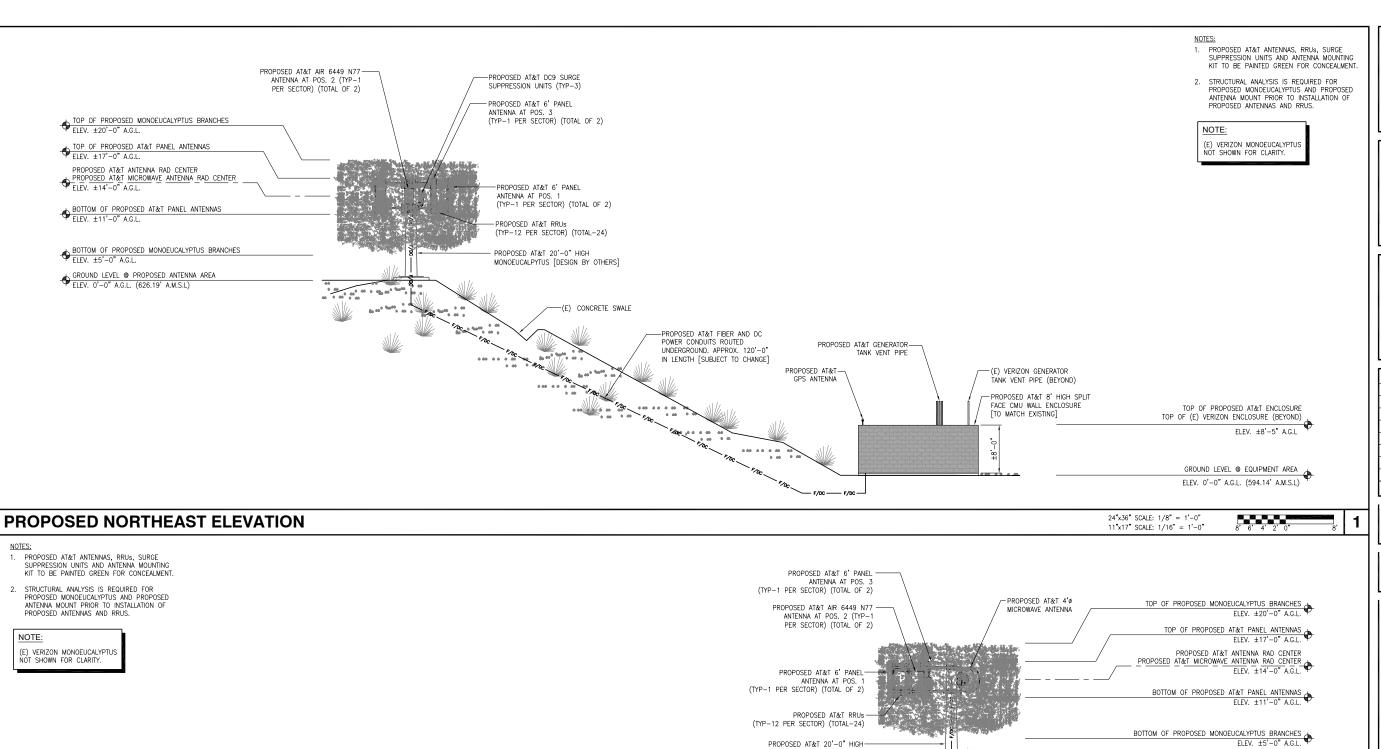

MONOEUCALPYTUS [DESIGN BY OTHERS]

(E) CONCRETE SWALE

PROPOSED AT&T FIBER AND DC-POWER CONDUITS ROUTED UNDERGROUND. APPROX. 120'-0"

IN LENGTH [SUBJECT TO CHANGE]

-PROPOSED AT&T GPS ANTENNA (BEYOND)

PROPOSED AT&T GENERATOR TANK-

(E) VERIZON GENERATOR -TANK VENT PIPE

TOP OF (E) VERIZON ENCLOSURE TOP OF PROPOSED AT&T ENCLOSURE (BEYOND)

GROUND LEVEL @ EQUIPMENT AREA

ELEV. 0'-0" A.G.L. (594.14' A.M.S.L)

PROPOSED SOUTHWEST ELEVATION

ELEV. ±8'-5" A.G.L

VENT PIPE (TYP) (BEYOND)



1997 ANNAPOLIS EXCHANGE PKWY., SUITE 200 ANNAPOLIS, MD 21401



16885 VIA DEL CAMPO CT., SUITE 318 SAN DIEGO, CA 92127 tel: (858) 432-4112 / (858) 432-4257

П			
	1	03/30/2023	SMARTLINK COMMENTS
	0	07/07/2021	100% ZD SET
	Α	05/19/2021	90% ZD's FOR REVIEW
	REV	DATE	DESCRIPTION

ISSUED DATE:

03/30/2023

100% ZD SET

LICENSURE:

CLL01419 AVENIDA CA 4159 COSTERO RISCO SAN CLEMENTE, CA 92673

SHEET TITLE:

ELEVATIONS


SHEET NUMBER:


2

A-3

24"x36" SCALE: 1/8" = 1'-0" 11"x17" SCALE: 1/16" = 1'-0"

GROUND LEVEL @ PROPOSED ANTENNA AREA ELEV. 0'-0" A.G.L. (626.19' A.M.S.L)

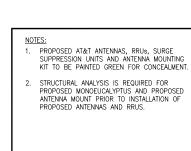

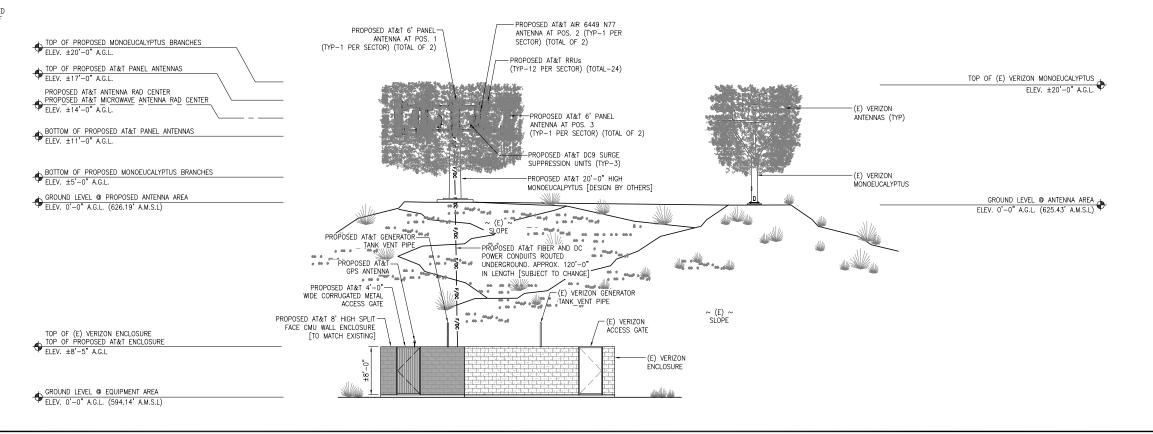

at&t

1452 EDINGER AVENUE
TUSTIN, CA 92780



1997 ANNAPOLIS EXCHANGE PKWY., SUITE 200 ANNAPOLIS, MD 21401



16885 VIA DEL CAMPO CT., SUITE 318 SAN DIEGO, CA 92127 tel: (858) 432-4112 / (858) 432-4257

Ι.			
	1	03/30/2023	SMARTLINK COMMENTS
	0	07/07/2021	100% ZD SET
	Α	05/19/2021	90% ZD's FOR REVIEW
	REV	DATE	DESCRIPTION

ISSUED-DATE:

03/30/2023

ICCUED FOR

100% ZD SET

LICENSURE:

PROJECT INFORMATION:

CLL01419 AVENIDA CA 4159 COSTERO RISCO SAN CLEMENTE, CA 92673

DRAWN BY: JDC
CHECKED BY: SVF

SHEET TITLE:

ELEVATIONS

SHEET NUMBER:

A-4

PROPOSED NORTHWEST ELEVATION

24"x36" SCALE: 1/8" = 1'-0"
11"x17" SCALE: 1/16" = 1'-0"
8" 6" 4' 2' 0"

NOT USED

2







ATTACHMENT 4





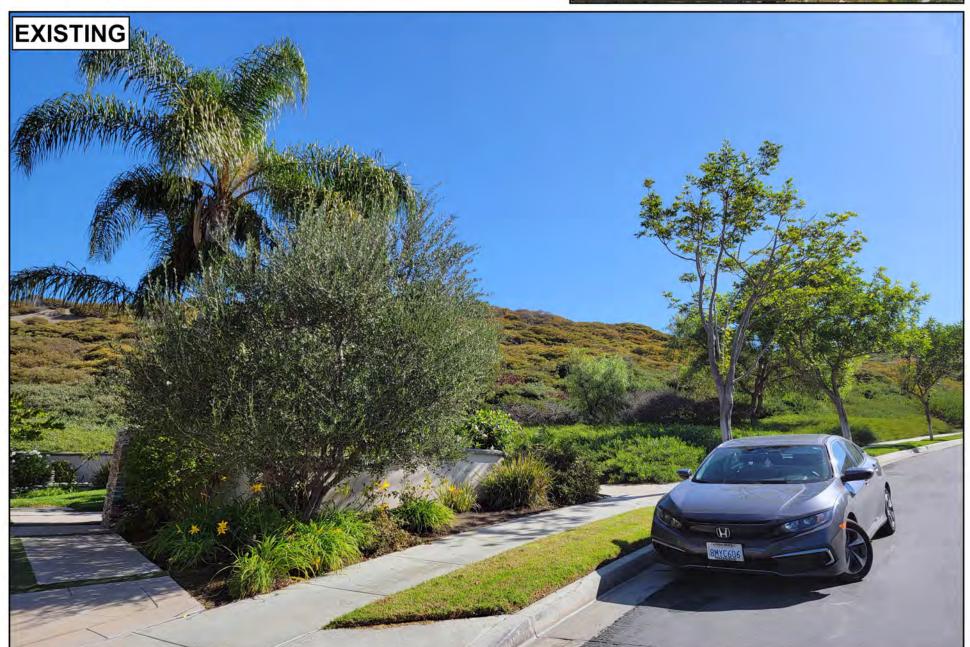


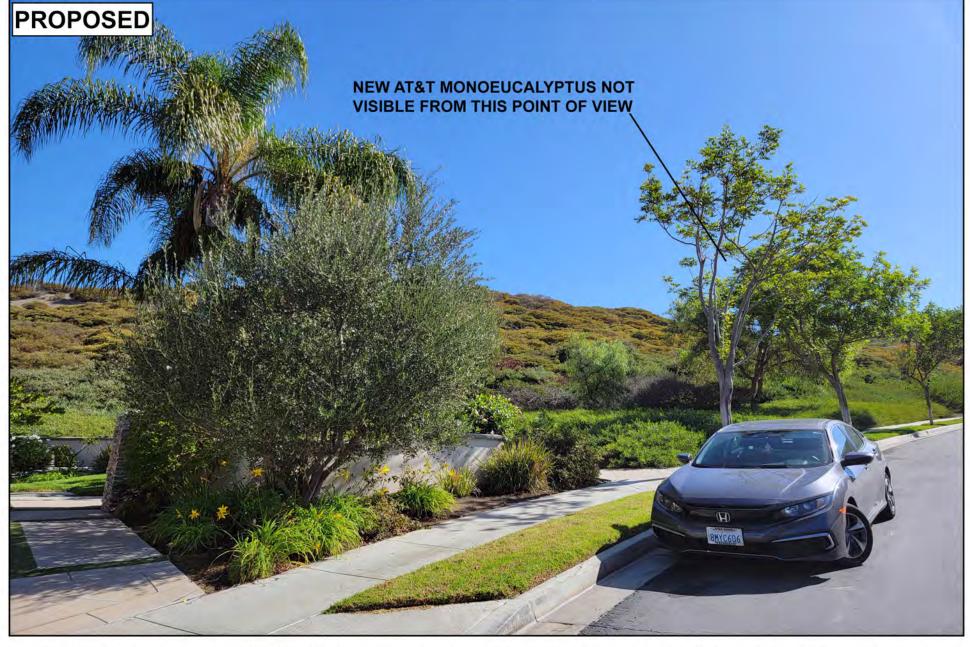


Accuracy of photo simulation is based upon information provided by project applicant. The proposed installation is an artistic representation of an antenna monument and it is not intended to be an exact reproduction. The final will have cables, cable ports and various attachments, such as antennas, nuts and bolts. Every effort will be made to disguise these components and they will not be readily apparent to the casual observer or passerby. However, upon close scrunity, the true nature of the installation will be apparent.





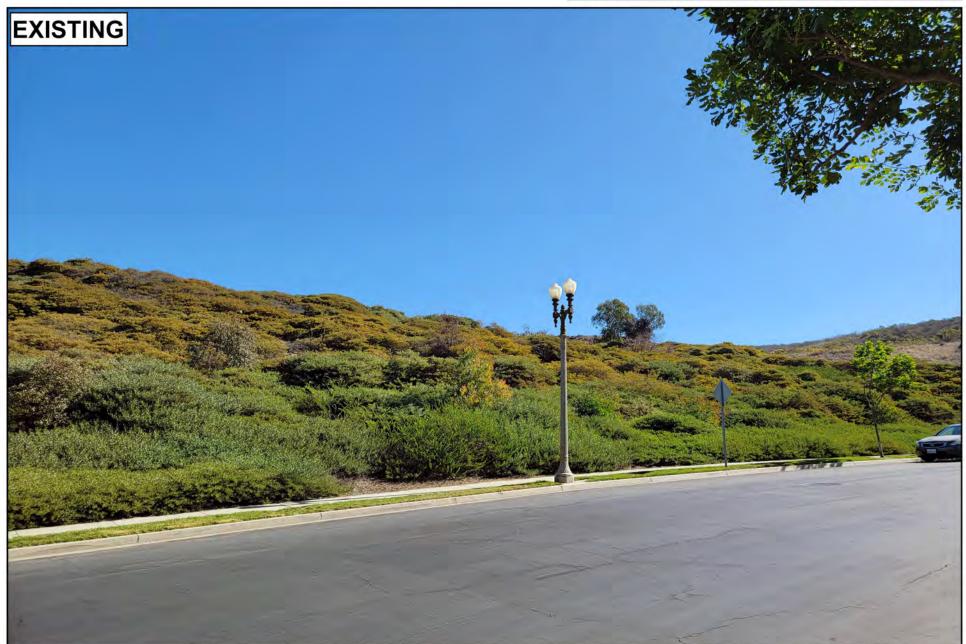

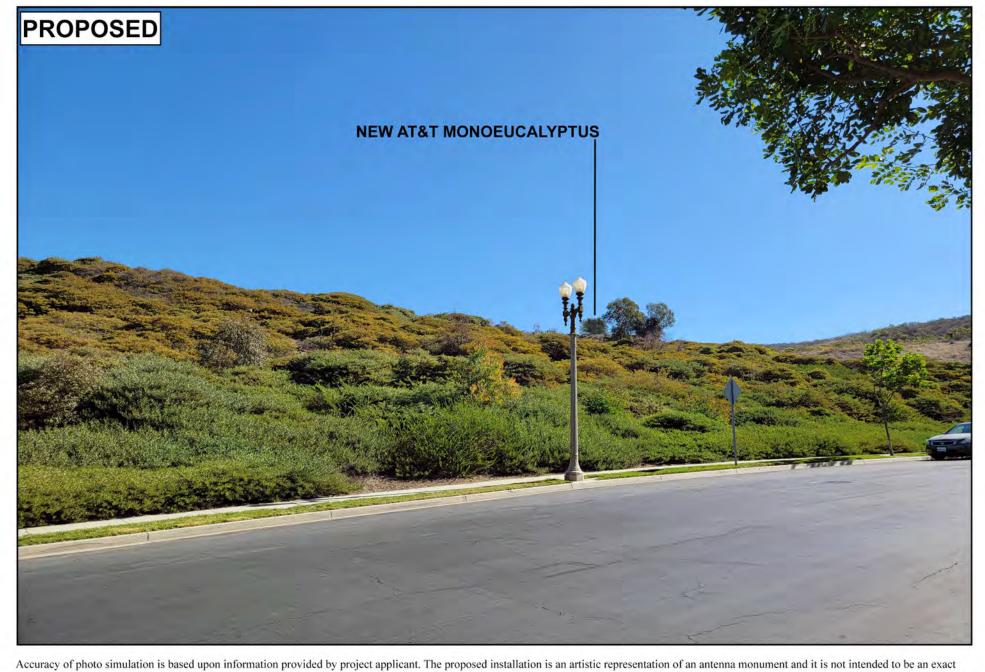

reproduction. The final will have cables, cable ports and various attachments, such as antennas, nuts and bolts. Every effort will be made to disguise these components and they will not be readily apparent to the casual observer or passerby. However, upon close scrunity, the true nature of the installation will be apparent.









Accuracy of photo simulation is based upon information provided by project applicant. The proposed installation is an artistic representation of an antenna monument and it is not intended to be an exact reproduction. The final will have cables, cable ports and various attachments, such as antennas, nuts and bolts. Every effort will be made to disguise these components and they will not be readily apparent to the casual observer or passerby. However, upon close scrunity, the true nature of the installation will be apparent.









Accuracy of photo simulation is based upon information provided by project applicant. The proposed installation is an artistic representation of an antenna monument and it is not intended to be an exact reproduction. The final will have cables, cable ports and various attachments, such as antennas, nuts and bolts. Every effort will be made to disguise these components and they will not be readily apparent to the casual observer or passerby. However, upon close scrunity, the true nature of the installation will be apparent.

Appendix 'B'

All coaxial cables should be concealed within the pole structure and should access the structure through the base (caisson). Raised ice bridge or cable trays are unacceptable.

Monopalm (Wireless facility disguised as a palm tree)

The monopalm structure should be designed for two carriers (if possible). Typically, collocating a second wireless carrier requires monopalm designs where one set of antennas are mounted within the palm fronds and the second set of antennas are mounted within the pineapple (growth pod).

The height of a monopalm structure should be reasonably comparable to the heights of existing or proposed natural palm trees in the vicinity of the installation.

The monopalm structure should have a sufficient number of palm fronds to simulate a natural tree.

The antennas should be hidden in the growth pod and or the trunk of the monopalm.

There should be a minimum space of five feet between the top of the antennas and the top of the faux tree.

Branch foliage color should be an olive green with varying color "fronds" to match an actual palm type of tree. A sample should be submitted for approval prior to fabrication.

A sample of bark cladding with a custom color should be submitted for approval prior to fabrication.

All coaxial cables should be concealed within the "trunk" and should access the structure through the base. Raised ice bridge or cable trays are unacceptable.

Monobroadleaf (wireless facility disguised as a broadleaf tree)

The monobroadleaf structure should be designed for a minimum of two carriers.

The height of the mono-broadleaf structure should be comparable to the height of existing or proposed natural broadleaf vegetation within the vicinity of the installation.

The mono-broadleaf structure should have a sufficient branch count to conceal the presence of antennas.

Branch disbursement should be random so that longer branches and shorter branches are intermingled to give a natural appearance.

Branches should exceed all antennas by a minimum of 12 inches. Branches should start at 15 feet above the ground.

There should be a minimum space of five feet between the top of the antenna and the top of the faux tree.

Branch foliage color should be an olive green with varying color "leaves" to match an actual broadleaf type of tree. The foliage should be extruded in the color instead of painted. A sample should be submitted for approval prior to fabrication.

A sample of bark cladding with a custom color should be submitted for approval prior to fabrication.

All antennas should be covered with "leafed antenna socks" that match the approved foliage color.

Antennas are to be mounted using stand-off mounts (horizontal, frame-type mounts are unacceptable). Support pipe mounts shall be concealed behind antennas and painted a darker shade or green (or black) with a "flat" paint finish to reduce reflection and visibility of the mounting.

All coaxial cables should be concealed within the "trunk" and should access the structure through the base. Raised ice bridge or cable trays are unacceptable.

Lollipops (single antenna mounted on a single pole usually in a set of three or four antennas)

Lollipop type antenna installations should only be approved in instances where other types of "stealth" installations would be more intrusive by attracting more attention.

Lollipops should be installed below ridgelines to the best possible extent to reduce the profile of the antennas appearing above the top of a slope.

Cross braces between individual antenna poles add additional bulk to the installation and should be discouraged.

Antennas and their support poles should be painted with appropriate colors to match the surrounding environment.