AGENDA ITEM: 4-A



STAFF REPORT SAN CLEMENTE ZONING ADMINISTRATOR

Meeting Date: September 17, 2020

PLANNER: David Carrillo, Assistant Planner

SUBJECT: Minor Exception Permit 20-120, Sheehan Residence, a

request to reduce the required front yard setback by 15% and street-side yard setback by 20% of a vacant corner lot property

for the construction of a new 2,828 sq. ft. residence.

LOCATION: 1107 South Ola Vista


ZONING/GENERAL Residential Low Zoning district and Coastal Zone Overlay district

PLAN: (RL-CZ)

PROJECT SUMMARY:

• The site is a 5,300 square-foot corner lot located in the Coastal Exclusion Zone (per Categorical Exclusion Order No. E-82-I) and surrounded by single-family residences. The site fronts two streets – South Ola Vista to the west and Paseo De Cristobal to the south. The site is currently vacant and was previously occupied by a single-story residence with an attached substandard two-car garage. Image 1 below is an aerial image of the site captured before the demolition of the residence.

Image 1 - Subject Site

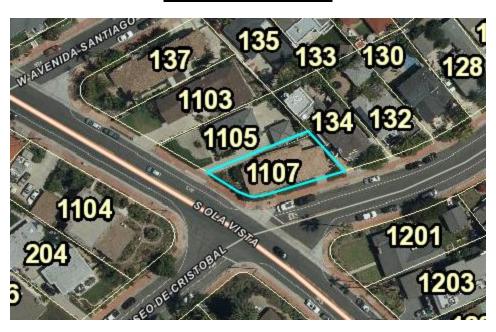

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 The applicant is requesting a reduction to the required front yard setback from 20 feet to 17 feet (15% reduction) and street-side yard setback from 10 feet to 8 feet (20% reduction).

- Concurrently, the applicant has submitted a building permit application for the construction of a new 2,828 square-foot two-story residence. The new residence would be constructed to the reduced front and street-side yard setbacks, and with a conforming two-car garage.
- Image 2 below shows the footprint of the old residence in red, the footprint of the proposed residence in black, and the reduced/required setbacks in dashed lines. The image shows how the old residence significantly encroached into the required front and rear yards. The new residence would improve the street appeal by increasing front and rear yard space, constructing the two-car garage at the required setback line from the south property line, and by improving the architecture on street-facing elevations with more articulation, as seen on plans (Attachment 4).

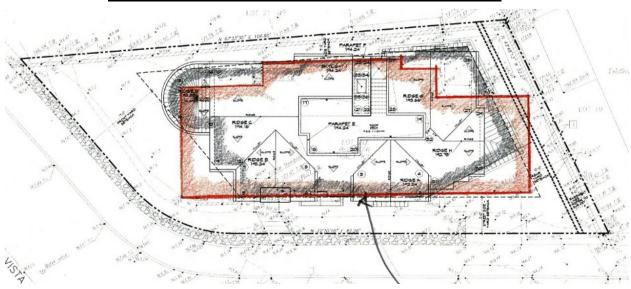


Image 2 – Proposed Street-Facing Garage Elevation

- The applicant has provided a conceptual landscape plan (Attachment 4) in compliance with the City's landscaping requirements and the State Model Water Efficiency Landscape Ordinance. New landscaping on the front and street-side yards is proposed, which further improves the street appeal.
- The character of the neighborhood consists of one and two-story residences with a mix of architectural styles. East of the subject site are interior lots with front property lines along Paseo De Cristobal, where a 20-foot front yard setback is required. Since the subject site's south property line along Paseo De Cristobal is determined to be a side property line, per Code definitions, the required street-side yard setback from the south property line is 10 feet. This staggered setback is typical in neighborhoods where rear property lines of corner lots abut the side property lines of interior lots

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(Image 3 below is an exhibit showing how the street-side yard setback of corner lots is shorter than front yard setbacks of interior lots). Therefore, the reduction of the required street-side yard setback from 10 feet to 8 feet, does not significantly alter the character of the neighborhood.

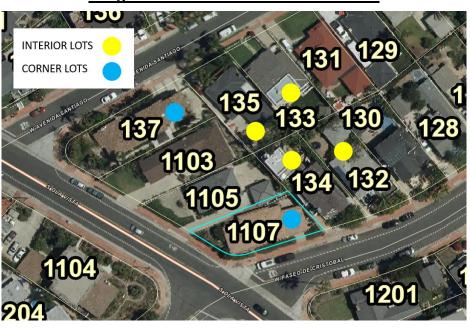


Image 3- Corner Lots and Interior Lots

- Zoning Ordinance Section 17.16.090, requires Zoning Administrator approval of a Minor Exception Permit (MEP) to allow a decrease of not more than 15 percent of the required front yard and 20 percent of the required width of a side yard.
- The request meets required findings for approval because:
 - The residential use of the corner lot will continue as intended by the RL zone and the exception does not significantly alter the neighborhood's street scene.
 - The property is subject to all development standards of the RL zone as neighboring properties in the same zone, with the exception of the reduced front and streetside yard setbacks The project maintains the one-story design of the existing residence located in a neighborhood consisting of one-, two-, and three-story residences.
 - The setback reductions does not restrict the property owner from providing two parking spaces on site, as required by Code. Providing on-site parking spaces helps reduce on-street parking congestion in the neighborhood.
 - The request does not preclude neighboring properties from being used as intended by the RL zone.
 - The exception maintains neighborhood compatibility and street appeal since the property is subject to landscape requirements that maintain a soft buffer between

Sheehan Residence Page 4

- the public right-of-way and the primary structure, consistent with neighboring properties.
- The property is in an urban area and development is required to meet the California Building Code and Orange County Fire Authority regulations.
- The project is Categorically Exempt from the California Environmental Quality Act (CEQA) pursuant to CEQA Guidelines Section 15305 (Class 5: Minor Alterations In Land Use Limitations) because the request is an exception to setback development standards on a lot with an approximate slope of 4%.
- Public comments have not been received on this item.

RECOMMENDATION

Staff recommends that the Zoning Administrator:

- Determine the project is Categorically Exempt from the requirements of the CEQA pursuant to CEQA Guidelines Section 15305 (Class 5: Minor Alterations In Land Use Limitations); and
- 2. Adopt Resolution ZA 20-023, approving Minor Exception Permit 20-120, Sheehan Residence, subject to attached conditions of approval.

Attachments:

- Resolution ZA 20-023
 Exhibit A Conditions of Approval
- 2. Location Map
- 3. Photos
- 4. Plans

RESOLUTION NO. ZA 20-023

A RESOLUTION OF THE ZONING ADMINISTRATOR OF THE CITY OF SAN CLEMENTE, CALIFORNIA, APPROVING MINOR EXCEPTION PERMIT 20-120, SHEEHAN RESIDENCE, TO REDUCE THE REQUIRED FRONT YARD SETBACK BY 15% AND STREET-SIDE YARD SETBACK BY 20% OF A CORNER LOT PROPERTY LOCATED AT 1107 SOUTH OLA VISTA

WHEREAS, on April 1, 2020, an application was submitted by Shana Sheehan, 51 Via Conocido, San Clemente, CA, 92673, Ramona Dr. Santa Ana, CA, 92707, for Minor Exception Permit (MEP) 20-120, and deemed complete on August 13, 2020; a request to reduce the required front yard setback by 15% and street-side yard setback by 20% of a corner lot property located at 1107 South Ola Vista in the Residential Low Zoning District and Coastal Zone Overlay District (RL-CZ), within the Coastal Exclusion Area. The site's legal description is N TR 822 BLK 6 LOT 20, and Assessor's Parcel Number 692-153-39; and

WHEREAS, the Planning Division has completed an initial environmental assessment of the above matter in accordance with the California Environmental Quality Act (CEQA) and recommends the Zoning Administrator determine the project is Categorically Exempt from CEQA pursuant to State CEQA Guidelines Section 15305 (Class 5: Minor Alterations In Land Use Limitations). This is recommended because the request is an exception to setback development standards; and

WHEREAS, on April 23, 2020, May 21, 2020, and August 13, 2020, the City's Development Management Team (DMT) reviewed the proposed project and determined it complies with the General Plan, Zoning Ordinance, and other applicable City ordinances and codes; and

WHEREAS, on September 17, 2020, the Zoning Administrator of the City of San Clemente held a duly noticed public hearing on the subject application, considered written and oral comments, and facts and evidence presented by the applicant, City staff, and other interested parties.

NOW, THEREFORE, The Zoning Administrator of the City of San Clemente does hereby resolve as follows:

<u>Section 1.</u> Incorporation of Recitals.

The Zoning Administrator hereby finds that all of the facts in the Recitals are true and correct and are incorporated and adopted as findings of the Zoning Administrator as fully set forth in this resolution.

Section 2. CEQA Findings.

Based upon its review of the entire record, including the Staff Report, any public comments or testimony presented to the Zoning Administrator, and the facts outlined below, the Zoning Administrator hereby finds and determines that the proposed project is Categorically Exempt from CEQA pursuant to State CEQA Guidelines Section 15305 (Class 5: Minor Alterations In Land Use Limitations).

The Class 5 exemption specifically exempts from further CEQA review, minor alterations in land use limitations in areas with an average slope of less than 20% which do not result in any changes in land use or density. The Class 5 exemption covers, but is not limited to, minor lot line adjustments, side yard, and set back variances not resulting in the creation of any new parcel. Here, the request is limited to the reduction of the required front yard and street-side yard setback on a lot with an approximate slope of 4%.

Furthermore, none of the exceptions to the use of the Class 5 categorical exemptions identified in State CEQA Guidelines section 15300.2 apply. The request will not result in a cumulative impact from successive projects of the same type in the same place, over time, in that, required setbacks may only be reduced by a maximum percentage. Here the applicant has requested the maximum allowed reduction of required setbacks. There are no unusual circumstances surrounding the project that result in a reasonably possibility of a significant effect on the environment in that there are no sensitive resources such as endangered species on the project site. The project will not damage scenic resources, including trees, historic resources, rock outcroppings, or similar resources. The project does not include any hazardous waste sites, and the project will not cause a substantial adverse change in the significance of a historical resource. Thus, the Class 5 exemption applies, and no further environmental review is required.

Section 3. Minor Exception Permit Findings

With respect to Minor Exception Permit (MEP) Findings 20-120, the Zoning Administrator finds as follows:

- A. The requested minor exception will not interfere with the purpose of the zone or the standards of the zone in which the property is located, in that:
 - 1. The residential use of the corner lot will continue as intended by the RL zone and the exception does not significantly alter the neighborhood's street scene by maintaining the front-yard character of the subject block along South Ola Vista and allowing the new two-car garage to be accessed from the existing street-side driveway. The front-yard character of the subject block along South Ola Vista consists of front yards without street-facing garages being the dominant feature; and
 - 2. The property is subject to all development standards of the RL zone as neighboring properties in the same zone, with the exception of the reduced front and street-side yard setbacks.
- B. The neighboring properties will not be adversely affected as a result of the

approval or conditional approval of the Minor Exception Permit, in that:

- 1. The setback reductions does not restrict the property owner from providing two parking spaces on site, as required by Code. Providing on-site parking spaces helps reduce on-street parking congestion in the neighborhood;
- 2. The request does not preclude neighboring properties from being used as intended by the RL zone; and
- The exception maintains neighborhood compatibility and street appeal since the property is subject to landscape requirements that maintain a soft buffer between the public right-of-way and the primary structure, consistent with neighboring properties.
- C. The approval or conditional approval of the Minor Exception Permit will not be detrimental to the health, safety or welfare of the general public, in that:
 - The setback reductions does not restrict the property owner from providing two parking spaces on site, as required by Code. Providing on-site parking spaces helps reduce on-street parking congestion in the neighborhood;
 - 2. The request does not preclude neighboring properties from being used as intended by the RL zone;
 - The property is subject to all development standards of the RL zone as neighboring properties in the same zone, with the exception of the reduced front and street-side yard setbacks;
 - 4. The property is in an urban area and development is required to meet the California Building Code and Orange County Fire Authority regulations.

Section 5. Zoning Administrator Approval.

Based on the foregoing recitals and findings, and the written and oral comments, facts, and evidence presented, the City of San Clemente Zoning Administrator approves Minor Exception Permit 20-120, Sheehan Residence, subject to the Conditions of Approval set forth in Exhibit A.

PASSED AND ADOPTED at a regular meeting of the City of San Clemente Zoning Administrator on September 17, 2020.

-	Cecilia Gallardo-Daly, Zoning Administrato

EXHIBIT A

CONDITIONS OF APPROVAL MINOR EXCEPTION PERMIT 20-120, SHEEHAN RESIDENCE

1.0 GENERAL CONDITIONS OF APPROVAL

1.1 Within 30 days of receipt of the signed conditions of approval, the applicant shall submit to the City Planner a signed acknowledgement concurring with all conditions of approval on a form to be provided by the City, unless an extension is granted by the City Planner.

Planning

1.2 The applicant shall defend, indemnify, and hold harmless the City of San Clemente and its officers, employees, and agents from and against any claim, action, proceeding, fines, damages, expenses. and attorneys' fees, against the City, its officers, employees, or agents to attack, set aside, void, or annul any approval or condition of approval of the City concerning this project, including but not limited to any approval or condition of approval of the City Council, Planning Commission, or City Planner. Applicant shall pay all costs, The City shall promptly notify the applicant of any claim, action, or proceeding concerning the project and the City shall cooperate fully in the defense of the matter. The City reserves the right, at its own option, to choose its own attorney to represent the City, its officers, employees, and agents in the defense of the matter. If the applicant fails to so defend the matter, the City shall have the right, at its own option, to do so and, if it does, the applicant shall promptly pay the City's full cost of the defense.

Planning

1.3 Use and development of this property shall be in substantial conformance with the approved plans, material boards and other applicable information submitted with this application, and with these conditions of approval. Any modifications to the project shall be reviewed by the City Planner in accordance with Zoning Ordinance Section 17.12.180.

Planning

1.4 The applicant shall comply with all applicable current and future provisions of the San Clemente Municipal Code, adopted ordinances, and state laws.

ΑII

1.6 MEP 20-120 shall be deemed to have expired if within three years of approval the project is not commenced, or the project permitted by the approved application has lapsed, as defined by Zoning Ordinance Section 17.12.150.

Planning

3.0 PRIOR TO ISSUANCE OF GRADING PERMITS

3.5 The applicant shall submit, and must obtain approval from the City Engineer, a precise grading plan as required by the City Grading Manual and Ordinance. (SCMC Chapter 15.36)

Public Works

3.9 The applicant shall provide separate improvement surety, bonds, or irrevocable letters of credit, as determined by the City Engineer, for 100% of each estimated improvement cost, as prepared by a registered civil engineer as approved by City Engineer, for the following applicable items: grading improvements; frontage improvements; sidewalks; sewer lines; water lines; onsite storm drains; and erosion control. In addition, the owner shall provide separate labor and material surety for 100% of the above estimated improvement costs, as determined by the City Engineer or designee. (SCMC Chapter 15.36)

Public Works

3.10 The applicant shall submit, and the City Engineer shall approve, frontage improvement plans. The applicant shall be responsible for the construction of all required frontage improvements as approved by the City Engineer including but not limited to the following:

Public Works

- A. Sidewalk, including construction of compliant sidewalk around drive approach or other obstructions to meet current City standards (2% cross fall) when adequate right-of-way exists. Since the street right-of-way is approximately 10 feet behind the curbface, a sidewalk easement is not anticipated to be required to be granted to the City.
- B. Contractor shall replace any damaged street improvements resulting from construction activities to the satisfaction of the City Inspector.
- C. An Administrative Encroachment Permit shall be applied for and approved to the satisfaction of the City Engineer for the portions of wall improvements existing within the street right of way.

(SCMC Chapter 15.36 and Sections 12.08.010, and 12.24.050)

3.18 Prior to the issuance of any permits, the owner or designee shall submit for review, and shall obtain the approval of the City Engineer or designee for, a soils and geologic report prepared by a registered geologist and/or geotechnical engineer which conforms to City standards and all other applicable codes, ordinances and regulations. [Citation – Section 15.36 of the SCMC]

Public Works

3.19 Prior to the issuance of any permits, the City Engineer shall determine that development of the site shall conform to general recommendations presented in the geotechnical studies, including

Public Works specifications for site preparation, treatment of cut and fill, soils engineering, and surface and subsurface drainage. [Citation – Section 15.36 of the SCMC]

3.20 The waste debris enclosure shall be of appropriate size to accommodate bins for recyclable materials, organic waste (food and landscape trimmings) and trash. For residential projects, all waste bins must be substantially hidden from view from any public street or alley. [SCMC Chapter 8.28]

Public Works

4.0 PRIOR TO ISSUANCE OF BUILDING PERMITS

4.1 The working drawings shall include within the first four pages a list of all conditions of approval included in this resolution.

Planning

5.0 PRIOR TO FINAL INSPECTION

Engineering

5.4 The applicant shall demonstrate to the satisfaction of the City Engineer and City Maintenance Manager that all street improvements have been completed and accepted and that any damage to new or existing street right-of-way during construction has been repaired/replaced. (SCMC Title 12)

Public Works

Surveys

5.8 Prior to approval to pour foundations, the applicant shall submit, and must obtain approvals from the City Planner and Building Official, a survey prepared by a registered civil engineer that is licensed to do surveying or a land surveyor confirming that the building foundations conform to the required setbacks as set forth on the approved plans.

Planning Building

7.0 OPERATIONAL CONDITIONS OF APPROVAL

7.17 The Applicant (including any property owners and managers, and their designees) understands and acknowledges that short-term lodging and boarding house uses are not permitted with the approval of this permit. Short-term lodging units (STLUs) and boarding houses require City-approval, and any unpermitted STLU or boarding house operations are prohibited. Applicant, property owner, and any successors in interest of the property shall be responsible for ensuring that all residential uses abide by the City's zoning requirements for the subject zone. [Citation - Section 17.04.060(B) & 17.32.030/17.36.020/17.40.030/17.52.030 of the SCMC]

Code Comp 7.18 The Applicant (including any property owners and managers, and their designees) shall ensure that discharge of washwater and other pollutants is prohibited from entering the storm drain system. Applicant must prevent pollutants (e.g. sediment, trash, food waste etc.) and any washwater used during cleanup from entering the storm drain system.

Code Comp WQ

7.19 The Applicant (including any property owners and managers, and their designees) shall use her/his best judgment and best management practices to ensure the residential activities on the premises will be conducted in a manner that will not be disruptive to neighbors. The property owner shall be responsible for ensuring compliance with the San Clemente Municipal Code (SCMC), and all conditions of approval contained herein. The Applicant (including any property owners and managers, and their designees) hereby understands that noncompliance with regulations and conditions of approval, shall be immediate grounds for citation pursuant to SCMC Section 8.52.030(Y), which states, "It is declared a public nuisance for any person owning, leasing, occupying or having charge or possession of any premises in this City to maintain such premises in such manner that ... A structure, improvement, property, and/or land use is not in compliance with terms and/or conditions of any City of San Clemente issued permit or approval," and any subsequent revision of this section of the code. [Citation - Section 8.52.030(Y) of the SCMC]

Code Comp

- * Denotes a modified Standard Condition of Approval
- ** Denotes a project-specific Condition of Approval





MEP 20-120, SHEEHAN RESIDENCE 1107 SOUTH OLA VISTA

PROJECT PHOTOGRAPHS



Front view of subject vacant site from South Ola Vista.



Side view of subject vacant site from Paseo De Cristobal

PROJECT PHOTOGRAPHS



View of subject vacant site (blue arrow) and neighboring property to the north (yellow arrow).



View of subject vacant site (blue arrow) and neighboring property to the east (yellow arrow).

SHEEHAN RESIDENCE

SAN CLEMENTE, CALIFORNIA

Project Address 1107 5. OLA	/ISTA Plan Re	view Project No	XX = Z	
Property Owner: BRIAN & SHAN	NA SHEEHAN Archite	ct: BRIAN MUE	HLBAUER - STUDIO 6	ARCH
Engineer: MIKE HOUSHMAND GOUVIS ENGINEER		xaminer: XXXX		40
inspector registered by the City of San Clen	ner, or the architect or engineer of record act nente and shall sign and submit this form to red, except with the specific permission of the	the Building Division.	owner, shall appoint an approved sp Selection of the special inspector/age	secial mey cann
Special Inspector: LARRY C	ARTER		Phone No: (949) 637-	569
- Inspection Agency (Firm): DEP	UTY 1 INSPECTION SE	RVICE	Phone No: (949) 859-	878
WWW.	OWNER	F 12 1 10 20	Phone No: (949) 285-	
Owner / Architect or Engi		The state of	4 4 7 4 10 , 0 1, 0	
The above signed hereby certifies that the sp. Chapter 17 of the California Building Code.	pecial inspector identified above has been er	gaged to perform the	pecial inspections outlined below as a	required
Compact 17 or the California Building Code.			***	-
☐ Type V cement required expos ☐ Special Inspection and concret	e lab testing IS REQUIRED ed. Submit concrete batch mix trip / Piles allation	ricket to building Precast Cor Steel Piles Cast-in Plac	inspector. crete Piles e Concrete Placement	The state of
☐ Field Welding	+ ž.			
☐ Steel Erection	☐ High Strength Bolting	Spray /	Applied Fire Proofing	
STRUCTURAL MASONRY Retaining Walls	1,000	Walls & Pil	asters	
MISCELLANEOUS	THE RESERVE		1,	-
STRUCTURAL OBSERVATI	ON IS REQUIRED (See attached	structural observa	tion form)	
☐ Epoxy Anchors / Bolts ☐ Shear Wall / Diaphragm Nailir	10	1 1 1	54 A	
O Other				111
Other	14			

ABBREVIATIONS

		_					
4,	AND ANGLE	E. FA	EAST EACH	LAB.	LABORATORY	S.	SOUTH
<u>~</u>	AT			LAM.	LAMINATE	S.C.	SOLID CORE
	CENTERLINE	E.D.F	DRINK FOUNTAIN	LAV.	LAVATORY	S.C.D.	SEAT COVER DISPENSER
£	DIAMETER OR ROUND	E.J.	EXPANSION JOINT	LKR.	LOCKER	SCHED.	SCHEDULE
ø #	POUND OR NUMBER	EL.	ELEVATION	LT.	LIGHT	S.D.	SOAP DISPENSER
(E)	EXISTING	ELEC.	ELECTRICAL			SECT.	SECTION
E)	EXISTING	ELEV.	ELEVATOR	MAX.	MAXIMUM	5.F.	SQUARE FEET
	ANCHOR BOLT	EMER.	EMERGENCY	M.C.	MEDICINE CABINET	SH.	SHELF
4.B.	ABOVE	ENGL.	ENGLOSED	M.B.	MACHINE BOLT	SHR.	SHONER
4BV. 4/6	AIR CONDITIONING	E.P.	ELECTRICAL PANELBOARD	MECH.	MECHANICAL	SHT.	SHEET
4COUS.	ACOUSTICAL	EQ. EQPT.	EQUAL EQUIPMENT	MEMB.	MEMBRANE	SIM.	SIMILAR
4.D.	AREA DRAIN	EM.C.		MET.	METAL	SKYLT.	SKYLIGHT
ADJ.	ADJUSTABLE		ELECTRIC WATER COOLER	MFG	MANUFACTURING	SL.	SLOPE
4.F.F.	ABOVE FINISH FLOOR	EXST.	EXISTING	MFR.	MANUFACTURER	5.N.D.	SANITARY NAPKIN DISPENS
AGGR.	AGGREGATE	EXP.	EXPANSION	MH.	MANHOLE	S.N.R.	
AGGR.	ALUMINUM	EXPO.	EXPOSED	MIN.	MINIMUM	5P.	SPACE
		EXT.	EXTERIOR	MIR.	MIRROR	SPEC.	SPECIFICATIONS
ALUM.	ALUMINUM	-		MISC.	MISCELLANEOUS	5Q.	SQUARE
<u> </u>	ANGLE	F.A.	FIRE ALARM	M.O.	MASONRY OPENING	5.5K.	SERVICE SINK
APPROX.	APPROXIMATE	F.A.U.	FORCED AIR UNIT	MTD.	MOUNTED	S.ST.	STAINLESS STEEL
ARCH.	ARCHITECT	F.B.	FLAT BAR	MUL.	MULLION	STA.	STATION
ARCH'L.	ARCHITECTURAL	F.C.	FAN COIL		NORTH	STD.	STANDARD
ASPH.	ASPHALT	F.D.	FLOOR DRAIN	N.		STL.	STEEL
		FDN.	FOUNDATION	N.I.C.	NOT IN CONTRACT	STOR.	STORAGE
		F.E.	FIRE EXTINGUISHER	NO. OR #	NUMBER	STRL.	STRUCTURAL
3D.	BOARD	F.E.C.	FIRE EXTINGUISHER CABINET	NOM.	NOMINAL	STRUCT'L	STRUCTURAL
BITUM.	BITUMINOUS	F.F.	FINISH FLOOR	N.T.S.	NOT TO SCALE	STRUCT	STRUCTURE
3LDG.	BUILDING	F.G.	FINISH GRADE			SUSP.	SUSPENDED
BLK.	BLOCK	F.H.C.	FIRE HOSE CABINET	0/	OVER	SM	SOLID WOOD
BLKG.	BLOCKING	FIN.	FINISH	O.A.	OVERALL	SYM.	SYMMETRICAL
BLT.	BOLT	FL.	FLOOR	OB5.	OBSCURE		
BM.	BEAM	FLASH.	FLASHING	O.C.	ON CENTER	T.B.	TONEL BAR
30T.	ВОТТОМ	FLUOR.	FLUORESCENT	O.D.	OUTSIDE DIAMETER (DIM.)	T.C.	TOP OF CURB
		F.O.C.	FACE OF CONCRETE	OFF.	OFFICE	TEL.	TELEPHONE
SAB.	CABINET	F.O.F.	FACE OF FINISH	O.H.C.	OVERHEAD CABINET	TER	TERRAZZO
S.B.	CATCH BASIN	F.O.M.	FACE OF MULLION	OPNG.	OPENING	T.4 G.	TONGUE AND GROOVE
SEM.	CEMENT	F.O.S.	FAGE OF STUDS	OPP.	OPPOSITE	THK.	THICK
CER.	CERAMIC	FPRF.	FIREPROOF			T.O.C.	TOP OF CURB
C.I.	CAST IRON	FRAM'G	FRAMING	PROST.	PRECAST	T.O.P.	TOP OF PARAPET
C.G.	CORNER GUARD	F.S.	FULL SIZE	PL.	PLATE	T.P.	TOP OF PAVEMENT
SLG.	CEILING	FT.	FOOT OR FEET	P.LAM.	PLASTIC LAMINATE	T.P.D.	TOILET PAPER DISPENSER
SLKG.	CAULKING	FTG.	FOOTING	PLAS.	PLASTER	TRD.	TREAD
SLO.	CLOSET	FURR.	FURRING	FLYND.	PLYWOOD	T.V.	TELEVISION
SLR	CLEAR	FUT.	FUTURE	PNL.	PANEL	T.M.	TOP OF WALL
5.0.	CASED OPENING		1010142	PTD.	PAINTED	TINH	TANKLESS WATER HEATER
SOI.	COLUMN	GA.	GAUGE	PLUMB.	PLUMBING	TYP.	TYPICAL
SONG.	CONCRETE	GALV.	GALVANIZED	PLYND.	PLYWOOD	HIF.	TIFICAL
CONN.	CONNECTION	G.B.	GRAB BAR	尼	PROPERTY LINE	UNF.	UNFINISHED
CONSTR.	CONSTRUCTION	GL.	GLASS	PR.	PAIR	U.O.N.	UNLESS OTHERWISE NOTED
SONT.	CONTINUOUS	GND.	GROUND	PT.	POINT	UR.	URINAL
5.0.F.	CORNER OF FINISH	GR.	GRADE	PREFAB	PREFABRICATED		
SORR.	CORRIDOR	GYP.	GYPSUM	P.T.D.	PAPER TOWEL DISPENSER	VERT	VERTICAL
STSK.	COUNTERSUNK	GYP, BD.	GYPSUM BOARD	P.T.D/R	COMBINATION PAPER TONEL	VEST.	VESTIBULE
SNTR.	COUNTER	G.B.	GYPSUM BOARD		DISPENSER 4 RECEPTAGLE		
STR.	CENTER		GYPSUM WALL BOARD	PTN.	PARTITION	M.	MEST
S.V.	GENTRAL VAGUUM	G.M.B.	GIFSOM MALL BOARD	P.T.R.	PAPER TOWEL RECEPTAGLE	W.	MITH
J. V .	CENTRAL VACCOM	H.B.	HOSE BIBB			M.C.	MATER CLOSET
DBL.	DOUBLE	H.G.	HOLLOW CORE	Q.T.	GUARRY TILE	ND.	MOOD
DEPT.	DEPARTMENT	HDMD.	HARDWOOD	R.	RISER	NDM.	MINDOM
D.F.	DRINKING FOUNTAIN	HDME.	HARDWARE	RAD.	RADIJS	M.H.	MATER HEATER
		H.M.	HOLLOW METAL	R	RADIJS	W/O	MITHOUT
DET.	DETAIL	HORIZ.	HORIZONTAL	R.D.	ROOF DRAIN	MP.	MATERPROOF
DIA.	DIAMETER	HR.	HOUR	REF.	REFERENCE	MSCT.	MAINSCOT
DIM.	DIMENSION	HT.	HEIGHT	REFR.	REFRIGERATOR	MT.	MATER TREATMENT
DN.	DOWN	H.V.A.C	HEATING VENTILATING	REV.	REVERSE		
2.0.	DOOR OPENING	H.V.A.C	AIR CONDITIONING	REINF	RENFORCE, REINFORCED		
OR,	DOOR	HORZ	HORIZONTAL	REINF RGTR.	REGISTER		
2.5.	DONNSPOUT	110-1-02					
2.5.P.	DRY STANDPIPE	LD.	INSIDE DIAMETER	REQ.	REQUIRED		
NC.	DISHMASHER	INSUL.	INSULATION	RESIL.	RESILIENT		
DMGS	DRAWINGS	INT.	INTERIOR	RM.	ROOM		
OMR.	DRANER	081.	INTERIOR	R.O.	ROUGH OPENING		
				RND	REDWOOD		

DESIGN DATA

THIS PROJECT SHALL COMPLY WITH ALL REGULATIONS AND ORDINANCES ADOPTED BY THE LOCAL GOVERNING AGENCIES AS WELL AS THE FOLLOWING: AS VELL AS 11 FE FOLLOWING:

CODE: 2019 CALIFORNIA RESIDENTIAL CODE

2019 CALIFORNIA BUILDING CODE

2019 CALIFORNIA PLIMBING GODE

2019 CALIFORNIA MECHANICAL CODE

2019 CALIFORNIA ELECTRICAL CODE

2019 CALIFORNIA ELECTRICAL CODE

2019 CALIFORNIA ENERGY CODE

CITY OF SAN CLEMENTE AMENDMENTS

LIBERDICTOR.

LIBERDICTOR.

LIBERDICTOR.

CITY OF SAN CLEMENTE

JURISDICTION: CITY OF SAN CLEMENTE ZONE: RL(CZ) CONSTRUCTION TYPE: V-B (SPRINKLERED) OCCUPANCY: R-3. U

SETBACKS: FRONT: REAR: SIDE: STREET SIDE: 8'-0" MAXIMUM HEIGHT: 25'-0"

LEGAL DESCRIPTION:

APN: TRACT: 692-153-39 822 BLOCK: SAN CLEMENTE COUNTY: ORANGE

SQUARE FOOTAGE CALCULATIONS:

4416.24 5.F. GROSS LOT AREA 1236.64 S.F. 1591.73 S.F FIRST FLOOR LIVABLE = SECOND FLOOR LIVABLE TOTAL LIVABLE = 2828.37 S.F. GARAGE = DECK = ROOF DECK = 525.05 S.F. 115.26 S.F. 266.72 S.F. TOTAL STRUCTURE 3735 40 S F LOT COVERAGE: LOT AREA = BUILDING AREA = ENTRY PORCH AREA = COVERED GARAGE ENTRY AREA = 1767.70 S.F 26.83 S.F 114.66 S.F BUILDING COVERAGE TOTAL = 1909.19 S.F <u>A</u> 43.23% LOT COVERAGE (50% MAX.) =

FIRE SPRINKLERS:

A FIRE SPRINKLER SYSTEM CONFORMING TO THE LATEST N.F.P.A. 13D STANDARD SHALL BE INSTALLED. DESIGN UNDER SEPERATE SUBMITTAL.

DEFERRED SUBMITTALS:

DEFERRAL OF ANY SUBMITTAL ITEMS SHALL HAVE PRIOR PEPROVAL OF THE BUILDING OFFICIAL. THE REGISTERED DESIGN PROFESSIONAL IN RESPONSIBLE CHARGE SHALL LIST THE

PROFESSIONAL IN RESPONSIBLE CHARGE SHALL LIST THE DEFERRED SUBMITTALS ON THE CONSTRUCTION DOCUMENTS FOR REVIEW BY THE BUILDING OFFICIAL. DOCUMENTS FOR DEFERRED SUBMITTAL ITEMS SHALL BE SUBMITTED TO THE REGISTERED DESIGN PROFESSIONAL IN RESPONSIBLE CHARGE WHO SHALL REVIEW THEM AND FORWARD THEM TO THE BUILDING OFFICIAL WITH A NOTATION INDICATING THAT THE DEFERRED SUBMITTAL DOCUMENTS HAVE BEEN THAT THE DEFERRED SUBMITTAL DOCUMENTS HAVE BEEN REVIENDE AND FOUND TO BE IN SENERAL CONFORMANCE TO THE DESIGN OF THE BUILDING. THE DEFERRED SUBMITTAL ITEMS SHALL NOT BE INSTALLED UNTIL THE DEFERRED SUBMITTAL DOCUMENTS HAVE BEEN APPROVED BY THE BUILDING OFFICIAL. DEFERRED SUBMITTALS SHALL BE IN ACCORDANCE MITH CALLFORNIA DOMINISTRATIVE CODE. CHAPTER 7, SECTION 7-126.

(2016 CBC CHAPTER 1 DIVISION II, SECTION 107.3.4.1) DEFERRED SUBMITTALS: 1. FIRE SPRINKLERS

PROJECT TEAM:

RCHITECT:

SHANA & BRIAN SHEEHAN 1107 S. OLA VISTA SAN CLEMENTE, CA 92672

STUDIO 6 ARCHITECTS, INC. 2753 CAMINO CAPISTRANO, SUITE A-100 SAN CLEMENTE, CA 92612 PHONE: (949) 398-5300 FAX. (949) 388-3930 CONTACT: BRIAN MUEHLBAUER EMAIL: brian@studio6architects.com

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20211 ACAGIA STREET, SUITE 120
NENPORT BEACH, CA 92660
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FAX: (944) 251-3694
CONTACT: DAVID PEDERSEN
EMAIL: dave@pdiandscape.com

EMAIL: CAVESPORINGSCAPE.C.
TOAL ENGINEERING
139 AVENIDA NAVARRO
5AN OLEMENTE, CA 92612
PHONE: (9491) 492-8586
FAX: (9491) 498-8625
CONTACT: CALEB RIOS
EMAIL: CRIOS@toalengineeria SURVEYOR:

GEOFIRM 801 GLENNEYRE ST., SUITE F LAGUNA BEACH, CA 92651 PHONE. (949) 494-2122 FAX: (449) 497-0270 CONTACT: KEVIN TRIGG EMAL: ktrigg@geofirm.com

GOUVIS ENGINEERING GROUP 15 STUDEBAKER IRVINE, GA 92612-1612 FRANCE, GA 92613-1612 FRANCE (GA) 93-8321 CONTACT: MIKE HOUSHMAND EMAIL: mhoushmandegouvisgroup.com

GOVIS ENGINEERING GROUP 15 STUDEBAKER IRVINE, CA 42616 PHONE: (949) 152-1612 PHONE: 949) 152-5321 CONTACT: MIKE HOUSHMAND EMALL: MHOUSHMAND EMALL: PROSERVING TOUR COM-

EMAIL: imicosimal degectivity of vi VAUGHN BUILDERS, INC. 638 CAMINO DE LOS MARES, SUITE H30444 SAN CLEMENTE, CA 92673 PHONE: (449) 142-4358 CONTACT: LANCE VAUGHN EMAIL: lance@vaughnbuilder.com

PROJECT SCOPE:

DETACHED RESIDENCE & ATTACHED 2 CAR GARAGE. CONSTRUCT A NEW 2828 S.F. SINGLE FAMILY DETACHED, TWO STORY HOME WITH AN ATTACHED 525 S.F. 2-CAR GARAGE AND 382 S.F. OF DECKS.

PLUMBING FIXTURES:

ON & AFTER JANUARY 1, 2014, RESIDENTIAL BUILDINGS INDERGOING PERMITTED ALTERATIONS, ADDITIONS OR IMPROVEMENTS SHALL REPLACE NONCOMPLIANT PLUMBING FIXTURES WITH WATER-CONSERVING PLUMBING FIXTURES, PLUMBING FIXTURE REPLACEMENT IS REQUIRED PRIOR TO ISSUANCE OF A CERTIFICATE OF FINAL COMPLETION, CERTIFICATE OF OCCUPANCY OR FINAL PERMIT APPROVAL BY THE LOCAL BUILD'S DEPARTMENT, A CERTIFICATE OF COMPLIANCE FOR WATER CONSERVING PLUMBING FIXTURES WILL BE REQUIRED AT FINAL INSPECTION. INDERGOING PERMITTED ALTERATIONS, ADDITIONS

ALL PLUMBING FIXTURES SHALL BE UPGRADED PER CGBSC 4,303 & CIVIL CODE SECTION 1101.1. AS

TOILETS: 1.28 GPF FOLETS: 1.20 GFF SHOMERHEADS (MAX. FLOM): 2.0 GFM @ 80 PSI LAVATORY FAUCETS (MAX. FLOM): 1.2 GFM @ 60 PSI KITCHEN FAUCETS (MAX. FLOW): 1.8 GPM @ 60 PSI OMEOWNER OR GENERAL CONTRACTOR TO PROVIDE ROMEDVANER OR GENERAL CONTRACTOR TO PROV A SIGNED COMPLETED COPY OF THE SEATOT FORM ' CITY HALL COUNTER STAFF PRIOR TO OBTAINING A PERMIT.

SHEET INDEX

ARCHITECTURE TITLE SHEET T24-MM TITLE 24 MANDATORY MEASURES T-1 TITLE SHEET

6N-1 GENERAL NOTES

6N-2 GENERAL NOTES

M-1 CALGREEN CHECKLIST

(N-2 CALGREEN CHECKLIST

(N-3 CITY NOTES

SCH-1 POOR & WINDON SCHEDULE &

CK-1-2 ENISH CYLEDIII ER

CK-1-2 ENISH CYLEDIII ER T24-1 TITLE 24 ENERGY COMPLIANCE SHEET LANDSCAPE DOOR & INNDOW SCHEDULE &
FINISH SCHEDULES
TOPOGRAPHIC SURVEY
ARCHITECTURAL SITE PLAN
ROOF HEIGHT ANALYSIS PLAN
FIRST & SECOND FLOOR PLANS
ROOF ACCESS FLOOR, RCP,
ELECTRICAL PLANS & STAIR PLANS
EXTERIOR ELEVATIONS
SECTIONS A, B, C, D, E & F
SECTIONS G & H
ROOF PLAN & ROOF ELECTRICAL PLAN
FIRST FLOOR RCP & ELECTRICAL PLANS
SECOND FLOOR RCP & ELECTRICAL PLANS
INTERIOR ELEVATIONS
ARCHITECTURAL DETAILS
ARCHITECTURAL DETAILS COVER SHEET
CONSTRUCTION PLAN
CONSTRUCTION DETAIL
LIGHTING PLAN
IRRIGATION PLAN
IRRIGATION DETAILS
PLANTING PLAN

PLANTING PLAN IRRIGATION & PLANTING SPECIFICATIONS

D-1 D-2 ARCHITECTURAL DETAILS ARCHITECTURAL DETAILS

STRUCTURAL STRUCTURAL
SN-1A GENERAL NOTES & REQUIREMENTS
SN-1B SPECIAL INSPECTIONS
SN-3 STRUCTURAL DETAILS & NOTES
SN-3 STRUCTURAL DETAILS & NOTES
S-1.1 FOUNDATION PLAN
SD-1.2 FLOOR & ROOF FRAMING PLANS
SD-1 STRUCTURAL FOUNDATION DETAILS
SD-2 GENERAL DETAILS & NOTES
SD-3 STRUCTURAL DETAILS

M-0.1 GENERAL NOTES & LEGENDS
M-0.2 EQUIPMENT SCHEDULES
M-3.1 FIRST & SECOND FLOOR HVAC PLANS
M-3.2 ROOF PLAN
MD-1 MECHANICAL DETAILS

PLUMBING

PLUMBING
P-0.1 GENERAL NOTES & SHEET INDEX
P-0.2 MATERIAL & FIXTURE SCHEDULES, CALCULATIONS
P-3.16 FLOOR FLANS, COLD / HOT WATER & NATURAL GAS
P-3.18 FLOOR FLANS, MASTE & VENT FIFING FAU CONDENSATE & STORM DRAIN
P-3.28 ROOF FLANS, COLD / HOT WATER & NATURAL GAS
P-3.19 DETAILS
P-D.10 DETAILS
P-D.11 DIAGRAMS

NOTE:

ESUANCE OF A BUILDING PERMIT BY THE CITY OF SAN CLEMENTE DOES NOT RELIEVE APPLICANTS OF THE LEGAL REQUIREMENTS TO OBSERVE COVENANTS, CONDITIONS AND RESTRICTIONS WHICH MAY BE RECORDED AGAINST THE PROPERTY OR TO CSTAIN PLAIS, YOU SHOULD CONTACT YOUR COMMUNITY ASSOCIATIONS PRIOR TO COMMENCEMENT OF ANY CONSTRUCTION AUTHORIZED BY THE PERMIT.







STUDIO 6 ARCHITECTS INC ARCHITECTURE + PLANNIN

PROJECT TEAM

PRINCIPAL ARCHITECT: BRIAN MUEHLBAUER DESIGN ARCHITECT: ROBERT WILLIAMS

HONE NUMBER AX NUMBER

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Ш SHEE 1107 S. OL SAN CLEN

PROJECT NUMBER:

2019020

NO.	DATE	DESCRIPTION
\triangle	4.29.20	PLANNING COR
	7.13.20	BLDG DEPT SU
	7.27.20	PLANNING COR

BLD'G DEPT CORF



SHEET TITLE: TITLE SHEET

SHEET NUMBER:

PROJECT NOTES:


POOLS SPAS, WALLS, FENCES, PATIO COVERS, FIRE PITS AND OTHER FREESTANDING STRUCTURES REQUIRE SEPARATE REVIEWS AND PERMITS.


GENERAL CONTRACTOR / SUBCONTRACTOR RESPONSIBILITY:

ALL POTENTIAL DESIGN, ENGINEERING AND SPECIFICATION CHANGES PROPOSED DURING CONSTRUCTION ARE REQUIRED TO BE PRESENTED TO AND APPROVED BY THE ARCHITECT PRIOR TO IMPLEMENTING CHANGES.

GENERAL CONTRACTOR AND ALL SUBCONTRACTORS ARE TO REVIEW AND BECOME FAMILIAR WITH THE ENTIRE SET OF CONSTRUCTION DOCUMENTS, INCLUDING BUT NOT LIMITED TO ARCHITECTURAL & STRUCTURAL DETAILS, REFLECTED CEILING PLANS, ELECTRICAL PLANS AND SCHEDULES, PRIOR TO BIDDING AND CONSTRUCTION. S. GENERAL CONTRACTOR IS RESPONSIBLE TO ENSURE ALL SUBCONTRACTORS BIDDING & CONTRACTED TO PERFORM WORK OR SUPPLY MATERIALS HAS RECEIVED AN ENTIRE SET OF CONSTRUCTION DOCUMENTS FOR THIS PROJECT.

4. GENERAL CONTRACTOR IS RESPONSIBLE TO ENSURE ONLY COPIES OF THE CITY AND/OR COUNTY APPROVED CONSTRUCTION DOCUMENTS ARE ON SITE AND USED FOR CONSTRUCTION, BID SETS ARE ALLOWED FOR CONSTRUCTION

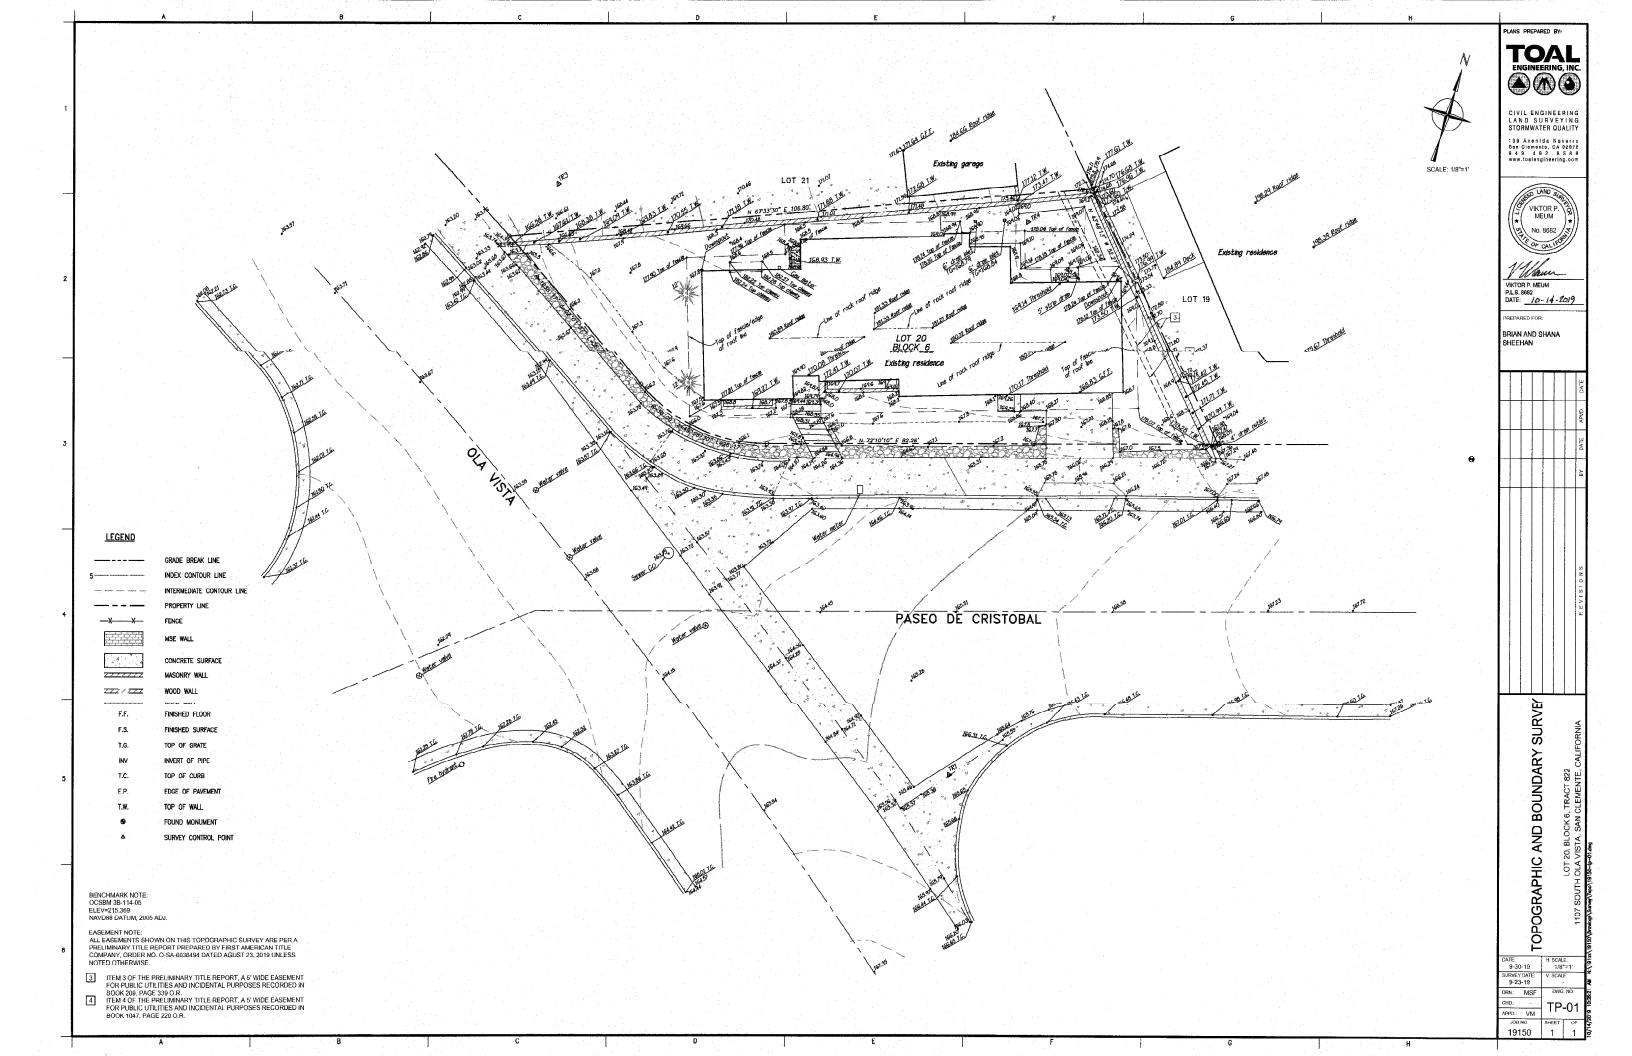

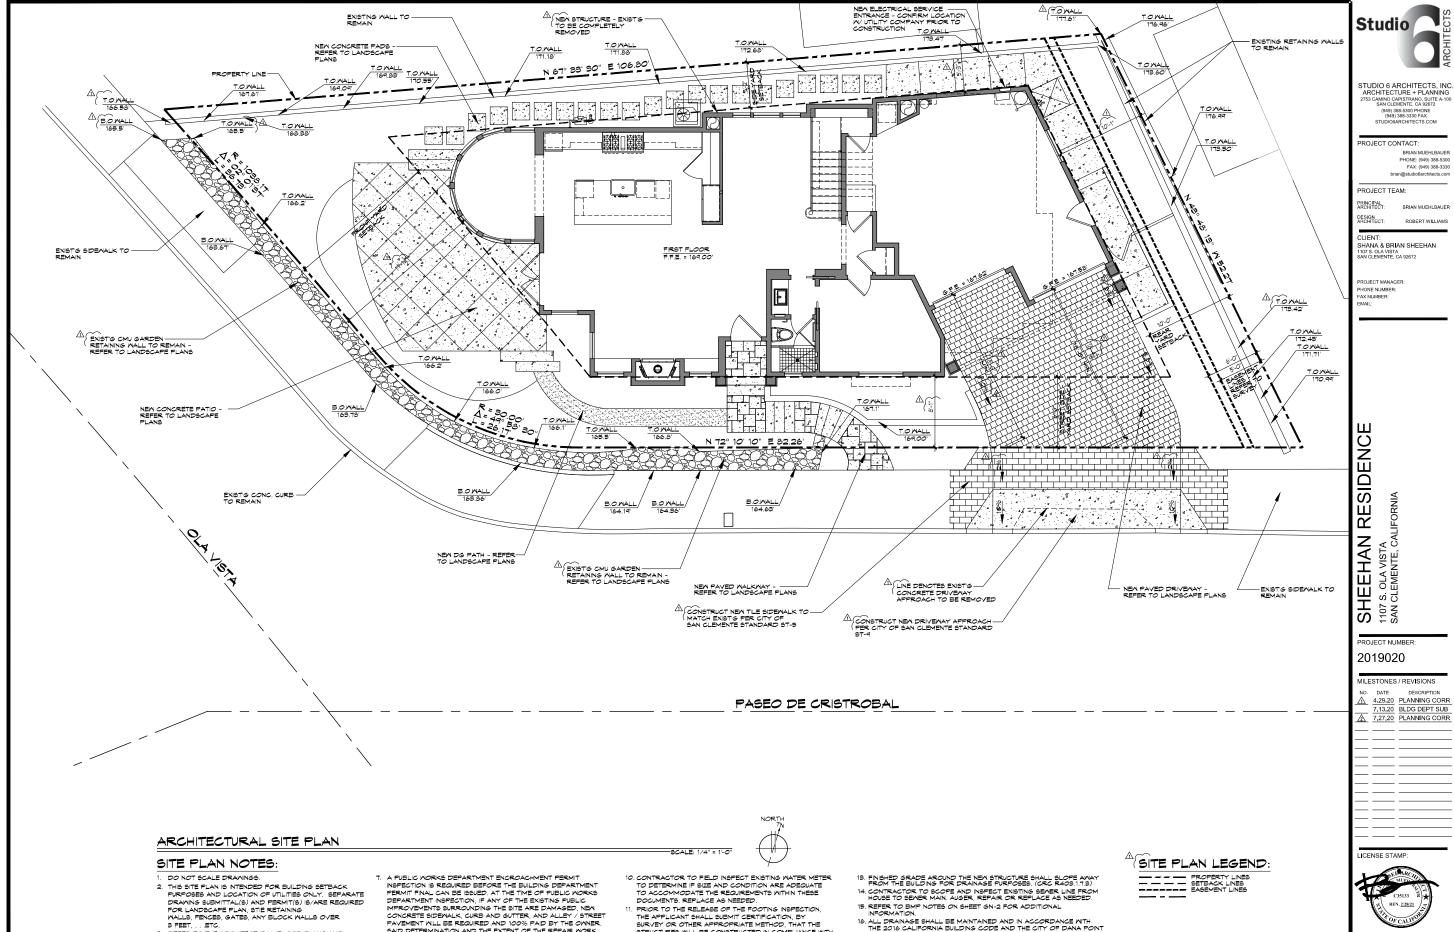

- D FEEL, ... ETC.

 D FEEL TO THE ARCHITECTURAL FLOOR PLANS AND GENERAL NOTES FOR ADDITIONAL ARCHITECTURAL INFORMATION.

 REFER TO EXTERIOR ELEVATIONS FOR ADDITIONAL INFORMATION.
- 5. AN APPROVED ENCROACHMENT PERMIT IS REQUIRED
- 5. AN APPROVED ENGROACHMENT PERMIT IS REQUIRED FOR ALL MORK ACTIVITIES MITHIN THE PUBLIC RIGHT-OF-MAY PRIOR TO ANY MORK.
 6. AN ENGROACHMENT AGREEMENT IS REQUIRED FOR ALL NON-STANDARD IMPROVEMENTS MITHIN THE PUBLIC RIGHT-OF-MAY, ALL NON-STANDARD IMPROVEMENTS SHALL COMPLY MITH CITY COUNCIL POLICY L-6.
- MPROVEMENTS SURKOUNDING THE SITE ARE DAMAGED, NEW CONCRETE SIDEMALK, CURB AND GUTTER, AND ALLEY / STREET PAVEMENT WILL BE REQUIRED AND 100% PAID BY THE OWNER. SAID DETERMINATION AND THE EXTENT OF THE REPAIR WORK SHALL BE MADE AT THE DISCRETION OF THE PUBLIC WORKS INSPECTOR.
- NOPPECION.

 ALL MORK RELATED TO MASTEMATER IN THE PUBLIC RIGHT-OF-MAY SHALL BE PERFORMED BY A C-42 LICENSED SANITATION SEMER CONTRACTOR OR AN A LICENSED SENERAL ENGINEERING CONTRACTOR.
- DETAIN FERMIT FROM CAL/OSHA FOR EXCAVATIONS
 5 FEET OR DEEPER AND / OR CONSTRUCTION OF BUILDING
 OR SCAFFOLDING MORE THAN 3 STORIES (36 FEET) HIGH.
 (CAL/OSHA COR TITLE 8 DIV. 1, CHAPTER 3.2, SUBCHAPTER
 2, SECTION 341)
- PRIOR TO THE RELEASE OF THE FOOTING INSPECTION, THE APPLICANT SHALL SUBMIT CERTIFICATION, BY SURVEY OR OTHER APPROPRIATE METHOD, THAT THE STRUCTURES WILL BE CONSTRUCTED IN COMPLIANCE WITH THE DIMENSIONS SHOWN AND IN COMPLIANCE WITH THE DIMENSIONS STOWN AND IN COMPLIANCE WITH THE SETBACKS OF THE APPLICABLE COMMUNITY ASSOCIATION GUIDELINES (IF ANY) AND LOCAL ZONING CODE.
- 12. THE DISCHARGE OF POLLUTANTS TO STORM DRAINAGE THE DISCHARGE OF FOLLUTANTS TO STORM DRAINAN SYSTEM (IF ANY) IS FORHIBITED. NO SOLID WASTE, PETROLEUM BYPRODUCTS, SOIL PARTICULATE, CONSTRUCTION NASTE MATERIALS, OR NASTEMATER GENERATED ON CONSTRUCTION SITES OR BY CONSTRUCTION ACTIVITIES SHALL BE PLACED. CONVEYED OR DISCHARGED INTO THE STREET, GUTTER OR STORM DRAIN SYSTEM (IF ANY)
- INFORMATION.

 INFORMATION.

 IS ALL DRAINAGE SHALL BE MAINTAINED AND IN ACCORDANCE WITH
 THE 2016 CALIFORNIA BUILDING CODE AND THE CITY OF DANA POINT
 MUNICIPAL CODE.

 17. CONTRACTOR TO FIELD VERIFY EXISTING GAS SERVICE SIZE AND
 CONDITION OF FIFING TO ACCOMMODATE NEW IMPROVENENTS AS
 DEPICTED ON THESE PLANS. REPAIR OR REPLACE AS REQUIRED.


DEMOLITION NOTES:


- SITE IS TO BE FENCED
- ALL DEBRIS SHALL BE MET AT TIME OF HANDLING TO PREVENT DUST.
- 3. STREETS AND SIDEWALKS ARE TO REMAIN CLEAR AND



SHEET TITLE ARCHITECTURAL SITE PLAN

SHEET NUMBER:

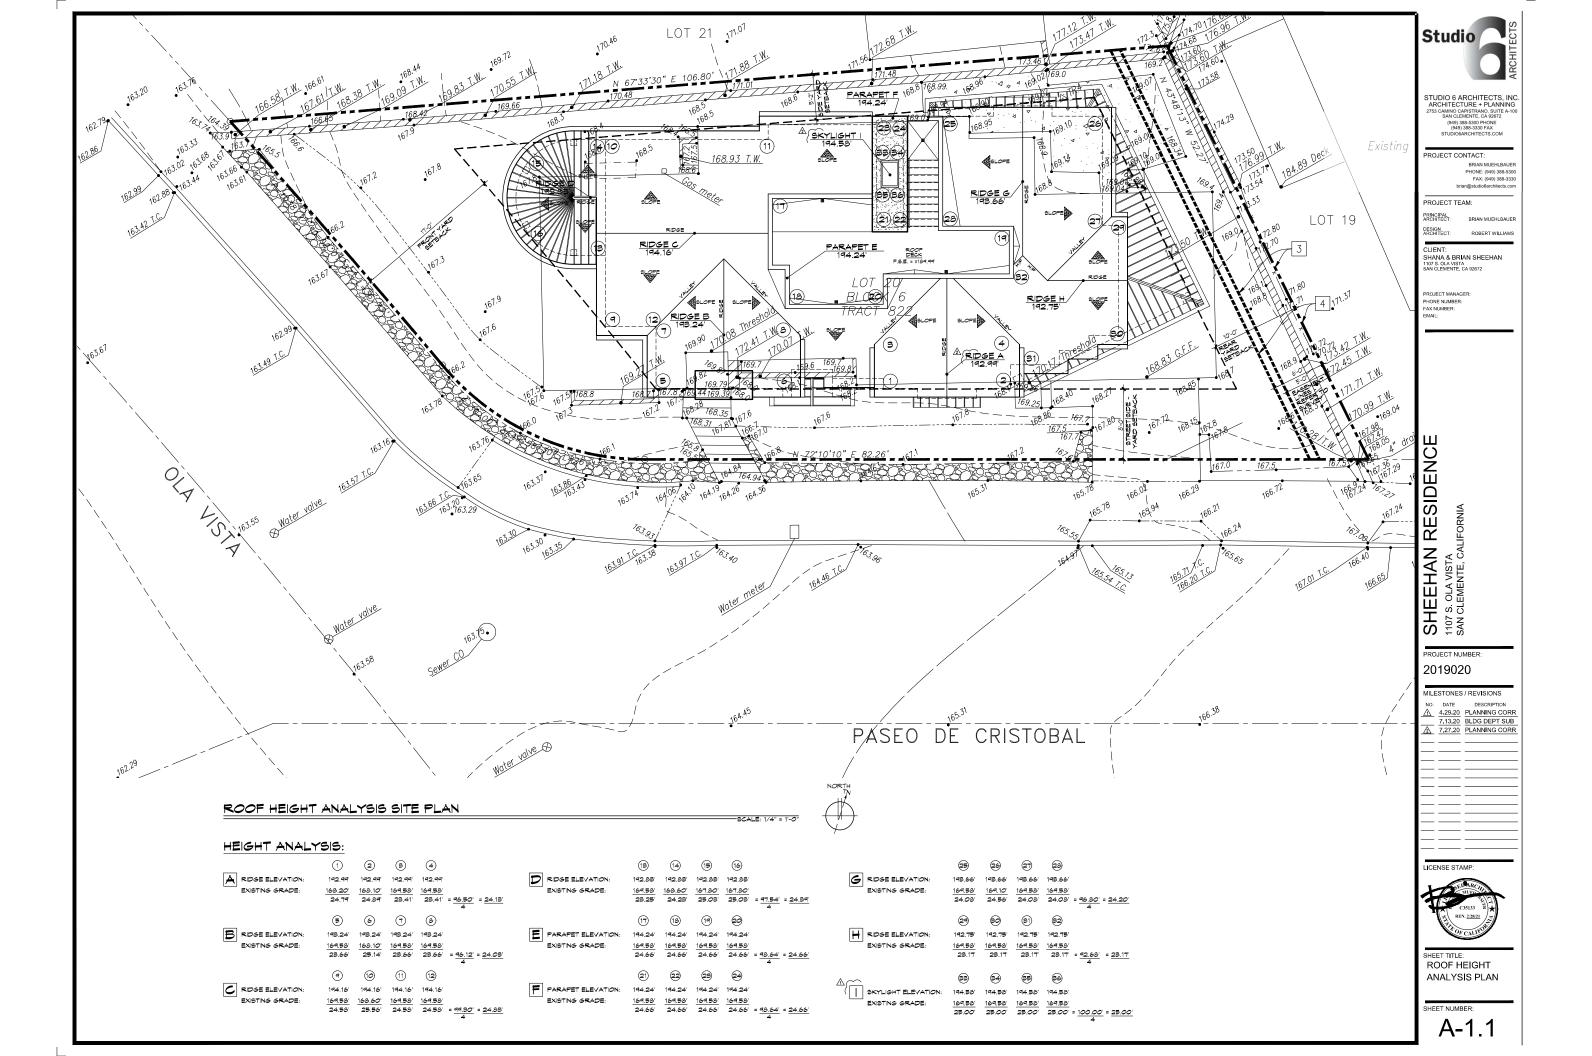

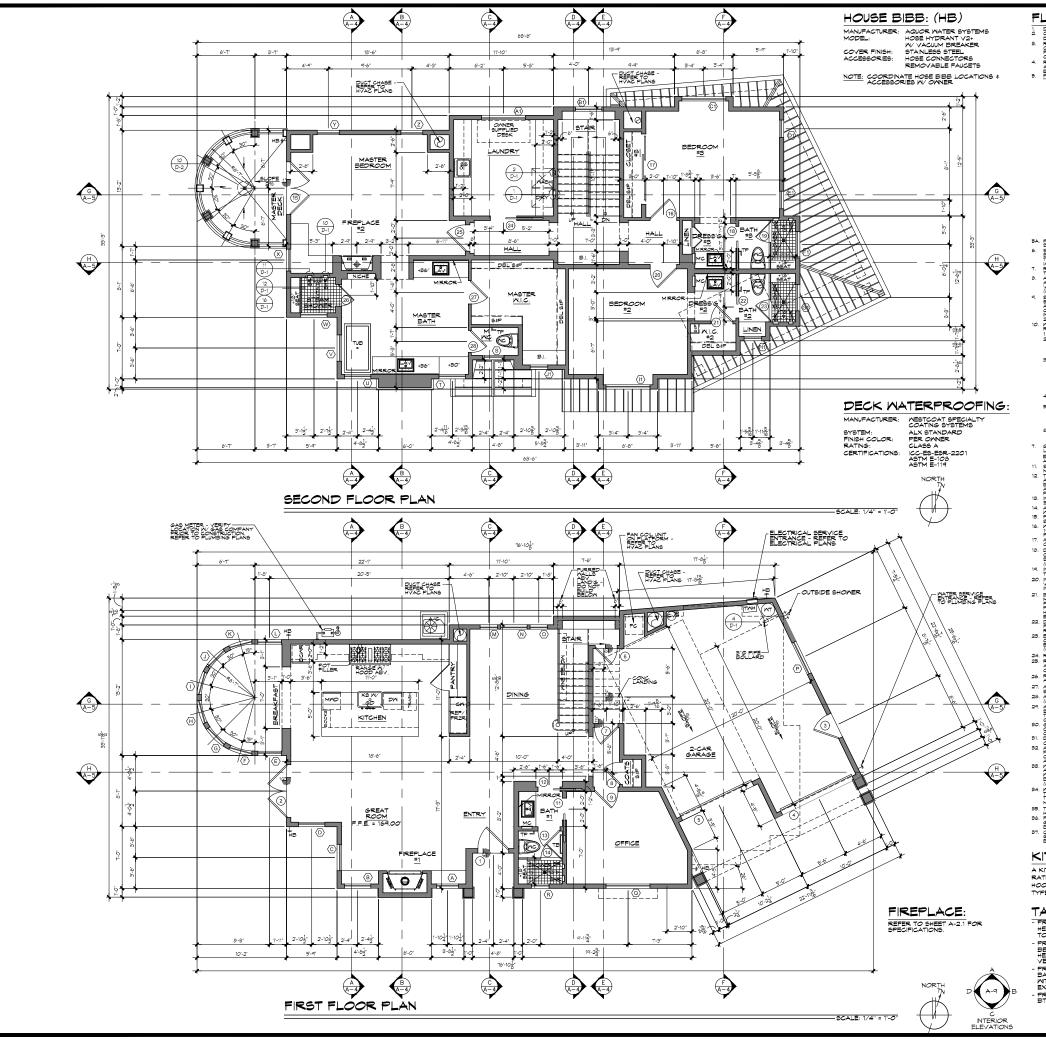

FLOOR PLAN NOTES:

- ELOR PLAN NOTES:

 1. DO NOTES LE DEMANGE PIX ALL DIMENSIONS I CLEARANCES AND REPORT ANY DESCRIPTION OF THE ARCHITECT REVIEW TO BESINNING CONSTRUCTION.

 9. REFER TO FINISH SCHEDULE FOR ALL PLUMBING FINITURES, APPLIANCES, CARRIET AND INTENDE THAN EXCHANGES AND INTENDES AND INTEND

- THE THAT FROVIDE BOALD AND THENVAL SHOCK FROTECTION.

 WILTELS SHOCKERHEADS BEALD AND THENVAL SHOCKER SHOCKERS TO THE CONTROLLED BY A SINGLE FLAT OF ALL NOT BEALD AND THE CONTROLLED BY A SINGLE FLAT OF ALL NOT BEALD AND A SINGLE FLAT OF SHALL NOT BEALD BY A SINGLE FLAT OF SHALL NOT BEALD BY A SINGLE FLAT OF SHALL NOT BEALD AND A SINGLE FLAT OF SHALL SHALL NOT BEALD BY A SINGLE FLAT OF SHALL BE SHALL SHALL
- E. RESORTAL LAVATORY FAUCETS.

 THE VASAMM FLOR ARE OF RESIDENTAL LAVATORY FAUCETS SHALL NOT EXCEED 1.2 GALLONS FER MINUTE AT 60 P.9.1. THE MINUTH FLOR ART 20 P.9.1.

 BE LESS THAN 2.5 GALLONS FER MINUTE AT 20 P.9.1.
- BE LESS THAN 0.3 SALLONS FER MINITE AT 20 P.5.1.
 KITCHEN PRINCETS:
 THE MAXIMUM FLOW RATE OF KITCHEN FAUCETS SHALL NOT EXCEED 1.3 SALLONS FER MINITE AT 60 P.5.1. KITCHEN FAUCETS MAY TEMPORARILY NOREAGE THE FLOW ABOVE THE MAXIMUM RATE, BUT NOT EXCEED 2.2 SALLONS FER MINITE AT 60 P.5.1. AND MUST DEFAULT TO A MAXIMUM FLOW RATE OF 1.3 SALLONS FER MINITE AT 60 P.5.1. AND MUST DEFAULT TO A MAXIMUM FLOW RATE OF 1.3 SALLONS FER MINITE AT 60 P.5.1. AND MUST DEFAULT TO A MAXIMUM FLOW RATE OF 1.3 SALLONS FER MINITE AT 60 P.5.1.
- NOTE:
 NOTE:
- UTALL MELI AFFLICADLE STANDARD REFERENCED IN TABLE TROLTOF THE CALTROCKIAL FIRST SHOPER COMPARTMENTS AND MALLS ABOUT BATTHERS NITH INSTALLED BHOMER HEADES SHALL BE FINISHED MITH A SMOOTH, NOVASSCREENT SKRACE TO A HEIGHT OF NOT LESS SHALL BE SHOWN THE ABOUT SKRACE TO A HEIGHT OF NOT LESS SHALL BE SHOWN THE MELT THE MOTE SHOPE SHOWN THE COMPLY MITH MELT THE MELT BHOME SHOPE SHOWN THE DOOR AND MINDOW SCHEDULE ON SHEET SCH-1 FOR ALL DOOR AND MINDOW TYPES AND SUES.

- REFER TO THE DOOR AND MINDOM SCHEDULE ON SHEET SCH-1 FOR ALL DOOR AND MINDOM THESE AND SIZELL, HAVE A TEMPORARY LIBBLE, THAT SHALL NOT BE REMOVED INTIL AFFECVED INSPECTION, ALL LABELS ARE TO SHOM THE SHAC, URLACTOR, AR LEAKAGE AND YIBBLE TRANSMITTANCE REFER TO SHEET SCH-1 FOR BLAZING VALUES (CALIFORNIA BINESOY CODE SECTION 16(3)) AND 10-11(3))

 SIEEPING ROOMS SHALL INVEX A MINDOM OR EXTERIOR DOOR FOR EVERGENCY ESCAPE BLEEPING ROOMS SHALL SHAP AND THAT FOR THE FOR THE SHAP WIST HAVE AN OPENAGE THE FOR THE SHAP OF THE SHAP AND SHAP AND THAT HAVE AND THAT HAVE AND THAT THE PROPERTY DOOR OR MINDOM SHALL BE OPENAGE FROM THE NEIDE TO PROVIDE A PULL, CLEAR OPENING MITHOUT THE USE OF SEPARATE TOOLS, PER OIL SECTION SECTION SHAP AND THAT SHAP
- 2015 C.R.C. SECTION SOLD. CHEMING MI HOU! I HE USE OF SEMANTE TOOLS, PER

 2015 C.R.C. SECTION SOLD.

 MINORIA (SLLAUNS) SAME SER FILLY TEMPERED LAMINATED SAFETY GLASS OR APPROVED

 SIGNATION IN ALL FIXED C.R.C. SECTION REPORT.

 GLAZING IN ALL FIXED C.R.C. SECTION REPORT.

 GLAZING IN AN INDIVIDUAL FIXED OR OPERABLE PANEL ADJACENT TO A DOOR AMERE THE

 NEAREST VERTICAL EDGE OF THE GLAZING IS MITHIN A 42 ARAC OF ENTIRE VERTICAL EDGE

 OF THE DOOR IN A CLOSED POSITION AND MIMERE THE BOTTOM EXPOSED EDGE OF THE GLAZING

 IS LESS THAN SOL AS DETT THE FLOOR OR MALKING SURFACE

 SIGNATING IN AN INDIVIDUAL FIXED OR OPERABLE PANEL THAN MEETS ALL OF THE FOLLOWING

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 AND THE POLLOWING AND THE POLLOWING AND THAN THE POLLOWING AND THE POLLOWING AND THAN THE POLLOWING AND
- 3. GLAZNIG IN AN NOVIDIAL FIXED OR OPERABLE PANEL THAT METER ALL OF THE FOLLOWING CONDITIONS.

 CONDITIONS EDER AREA OF AN NOVIDIAL PANE IS LARGER THAN 9.5 P.

 E. THE EDITION EDISE OF THE GLAZNIG IS LESS THAN 19. INCHES ABOVE THE FLOOR.

 C. THE TOP EDISE OF THE GLAZNIG IS NOVE THAN 19. INCHES ABOVE THE FLOOR.

 D. ONE OR MORE MALKING SILVANOS AREA WITHIN 30. INCHES MEMBERS HORIZONTALLY

 AND IN A STRAIGHT LINE, OF THE GLAZNIG THAN 19. INCHES ADVICE THE FLOOR.

 GLAZING IN GLAZDIG IRALINOS, INCLUDING STRUCTURAL PALIFIEST FAMELS I NONSTRUCTURAL

 GLAZING IN MALL ENCLOSURES OR PREVIOUS CONTINUOS OF FACING HOT TUBS. SPAS.

 MHELPOLIS, SALVAS, STRAIN ROOMS, BATTUES, SHOOKERS I INDOOR OR OUTDOOR SHIMING FOOLD WHERE THE BOTTOM EXPOSED EDISE OF THE SLIZING IS. LESS THAN 60' MEASURED

 GLAZING IN HERE THE BOTTOM EXPOSED EDISE OF THE SLAZING IS. LESS THAN 60' MEASURED

 GLAZING HEREET THE BOTTOM EXPOSED EDISE OF THE SLAZING IS LESS THAN 60' MEASURED

 GLAZING HEREET THE BOTTOM EXPOSED EDISE OF THE SLAZING IS HALL AFFLY TO SINGLE

 GLAZING HEREET THE BOTTOM EXPOSED EDISE OF THE SLAZING IS LESS THAN 50' MEASURED

 THE PANEL OF THE ADSACRATION EXPOSED EDISE OF THE SLAZING IS. LESS THAN 50' MEASURED

 THE PANEL OF THE ADSACRATI AND INSTRUCTED OF STARMANS, LANDINGS BETTWEEN FLIGHTS

 SALVING I ALL PANERS THE DISTORM EXPOSED OF THE SALVING INSTRUCTE THAN 50' MEASURED

 THE PANEL OF THE ADSACRATI PARTIES HOUR TOUTOM OF A STARMAN MEASURE THAN 50' MEASURED

 THE PANEL OF THE ADSACRATI PARTIES HOUR TOUTOM OF A STARMAN MEASURE THAN 50' MEASURED

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- CLAINS AND AMERICAN TO THE LANDING AT THE BOTTOM OF A STARKAY MIRRE THE SCALING IS LESS THAN 36 ABOVE THE LANDING AND MITHIN OF HORIZONTALLY OF THE BOTTOM TREAD. EXCEPTIONS, ARE AS STATED IN THE CALIFORNIA RESIDENTIAL CODE AS AMENDED BY LOCK SCHOOLS BLOCKES WIST BE OF APPROVED TEMPERED OR SAFETY GLAZING AND DOOR MUST SANIOL OF FROM THE CONTROL OF A SAFETY GLAZING AND DOOR MUST SANIOL OF FROM THE CONTROL OF T
- 1. SHONER ENCLOSURES MIST BE OF APPROVED TEMPERED OR SAFETY SLAVE AND DOOR MUST SHINE OF OT OF SHOWER STON, OF AN OFFERABLE MYORD HOCATED WORST THAN 12 MORE THAN
- NETALLATION NETEL ON DURING CONSTRUCTION
 NETALLATION CERTIFICATES OFERATION INFORMATION MAINTENANCE INFORMATION AND
 VENTILATION INFORMATION MUST BE PROVIDED TO THE BUILDING OWNER PRIOR TO FINAL
 INSPECTION.

- REPERIOR.

 REPERIOR SHALL HAVE A MINIMA CELLING HEART OF 6-9° AT THE CELLING HEART AS INCIDENT AS A SHALL HAVE A MINIMA CELLING HEART OF THE INTURES THE CELLING HEART ABOVE PINIMES THAT DOES HAVE BEEN HEART ABOVE PINIMES THAT THE PRIVILE IS CAPABLE OF BEING 1950 FOR THE NEXT PERIOR PRIVILES AT THE OWNER HAVE A HIMMON CELLING PROPERTY OF A THE SHOP AND THE SHALL HAVE A HIMMON CELLING PROPERTY OF A SHALL HAVE A HIMMON CELLING HAVE A HIMMON CELLING PROPERTY OF A SHALL HAVE A HIMMON CELLING PROPERTY OF A HIMMON PROPERTY OF A HIMMON
- (MIL DU I) I CPC 508.14(2)

 REFER TO THE REFLECTED CELING FLANS FOR CELING AND SOFFIT HEIGHTS,
 REFER TO STRUCTURAL DEVANNOS FOR ALL FOUNDATION AND FRAMMS REQUIREMENTS
 ALONS WITH ANY CITY REQUIRED STRUCTURAL COSSER/PATION(S), SPECIAL INSPECTION
 CERTIFICATION(S), AND/OR TESTING FORMS
- 26. REFER TO SHEET (T24.1) FOR THE TITLE-24 ENERGY CALCULATION FORMS AND MANDATORY REQUIREMENTS FOR ENERGY COMPLIANCE.

- 26. REFER TO SHEET (TAIL) FOR THE TITLE-34 ENERGY CALCULATION FORMS
 AND MANDATORY REQUIREMENTS FOR ENERGY COMPLAKE.

 27. APPLIANCES INSTALLED IN GARAGE SHALL BE LOCATED ON PROTECTED SO THEY ARE NOT
 APPLIANCES INSTALLED IN GARAGE SHALL BE LOCATED ON PROTECTED SO THEY ARE NOT
 CIFC 603.9, 103.23 ± 103.41)

 28. ALEDONAL DE BREEN MUST HAVE AN APPROVED ANTI-SHALL BE REVENTION DEVICE.

 (CIFC 603.9, 103.23 ± 103.41)

 29. AND AND ANTI-SHALL BE INTERNATION OF THE APPLIANCE AND PROCEDURE. THE SHALL BE BITCHED ON THE GAS LINE DOWNSTREAM OF THE 6.46 APPLIANCE
 THAT SHALL BE SHARL A TESTITING INTO APPED NIPPLE THE BOTTOM OFLET OR.

 29. OTHER SECONS 20D DEVELOPED (CIFC 102.1) ISSUED ON LOCATED ON THE SHALL BOTTOM OFLET OR.

 29. OTHER SECONS 20D DEVELOPED (CIFC 102.1) ISSUED AND COMPONENT OF ENNISS SHALL BE
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 A METER ATTERS BUT ALL SE ANAMESE OR STRAFFED TO THE PTRYCTHES OF RESET HORIZONTYPE PARTER FER DETAIL UPG. A MOJOR TANKLESS TYPE PARTER HEATER PER ANAMEDIATION TO THE PARTER HEATER PER ANAMEDIATION OF THE PARTER HEATER SHALL BE IN ACCORDANCE WITH THE PIRET THE PROPERTY OF THE PARTER HEATER SHALL BE IN ACCORDANCE WHEN INSTALLED IN THE SECOND ANAMEDIATION OF THE PARTER HEATER PARTER THE PARTER

KITCHEN EXHAUST HOOD:

A KITCHEN EXHAUST WITH A MINIMUM RATE OF 100 CFM AND A MAXIMUM SOUND RATING OF 3 SONE FOR INTERMITTENT OPERATION IS REQUIRED, THE KITCHEN HOOD SHALL BE DUCTED TO THE OUTSIDE REGARDLESS OF FUEL OR HOOD

TANKLESS MATER HEATER MEASURES:

PROVIDE A 120V ELECTRICAL RECEPTACLE THAT IS WITHIN 36" OF THE WATER HEATER & ACCESSIBLE TO THE WATER HEATER WITH NO DESTRUCTIONS, REFER TO MATER HEATER MANUFACTURES FOR EXACT POWER REQUIREMENTS.

PROVIDE A CATEGORY III OR IN VENT, OR A 177E B VENT WITH STRAIGHT PIPE BETWEEN THE QUTSIDE TERMINATION AND THE SPACE WHERE THE WATER HEATER IS INSTALLED REFER TO MATER HEATER MANUFACTURES FOR EXACT VENTING REQUIREMENTS.

PROVIDE A CONDENSATE DRAIN THAT IS NO MORE THAN 2" HIGHER THAN THE BASED OF THE INSTALLED MATER HEATER AND ALLOWS NATURAL DRAINAGE MITHOUT PUMP ASSISTANCE, REFER TO MATER HEATER MANUFACTURER POR EXACT DRAIN LOCATION.

PROVIDE A GAS SUPPLY LINE WITH THE CAPACITY OF AT LEAST 200,000 BTU/HR TO THE WATER HEATER.



STUDIO 6 ARCHITECTS INC ARCHITECTURE + PLANNIN 2753 CAMINO CAPISTRANO, SUITE A-10 SAN CLEMENTE, CA 92672

ROJECT CONTACT:

BRIAN MUEHLBAUE PHONE: (949) 388-5300 FAX: (949) 388-3330 brian@studio6architects.com

PROJECT TEAM

RINCIPAL RCHITECT:

BRIAN MUEHLBAUER

DESIGN ARCHITECT: ROBERT WILLIAMS

CLIENT: SHANA & BRIAN SHEEHAN 1107 S. OLA VISTA SAN CLEMENTE, CA 92672

PROJECT MANAGER PHONE NUMBER: FAX NUMBER:

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PROJECT NUMBER: 2019020

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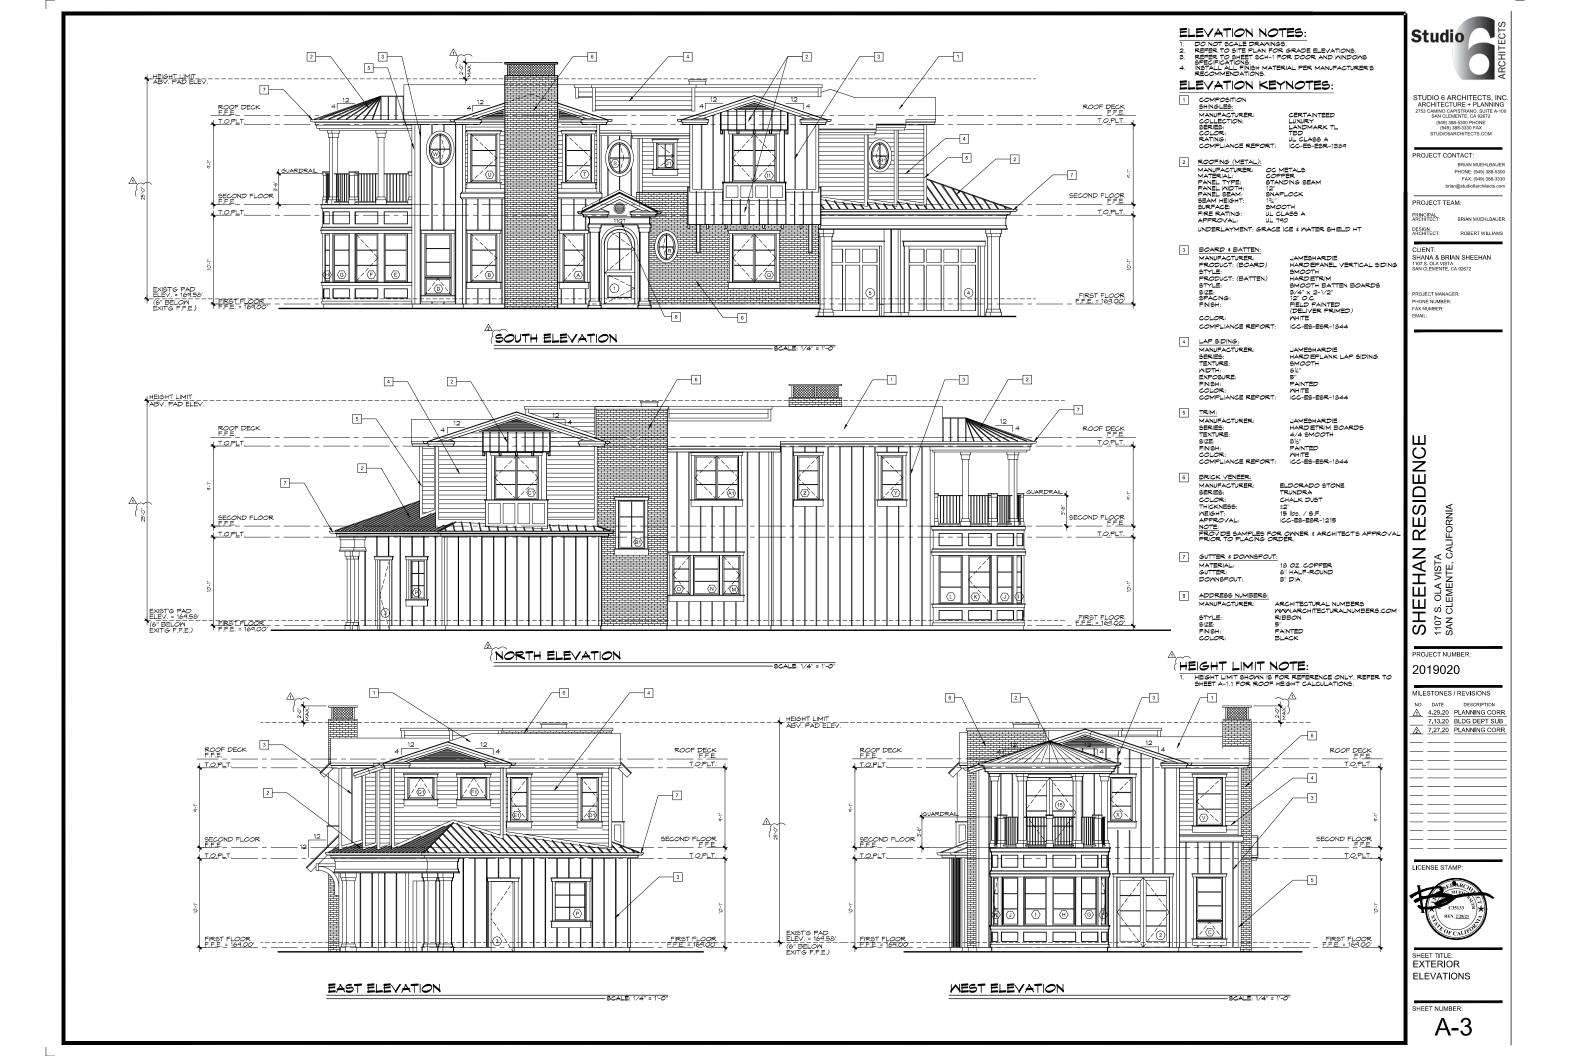
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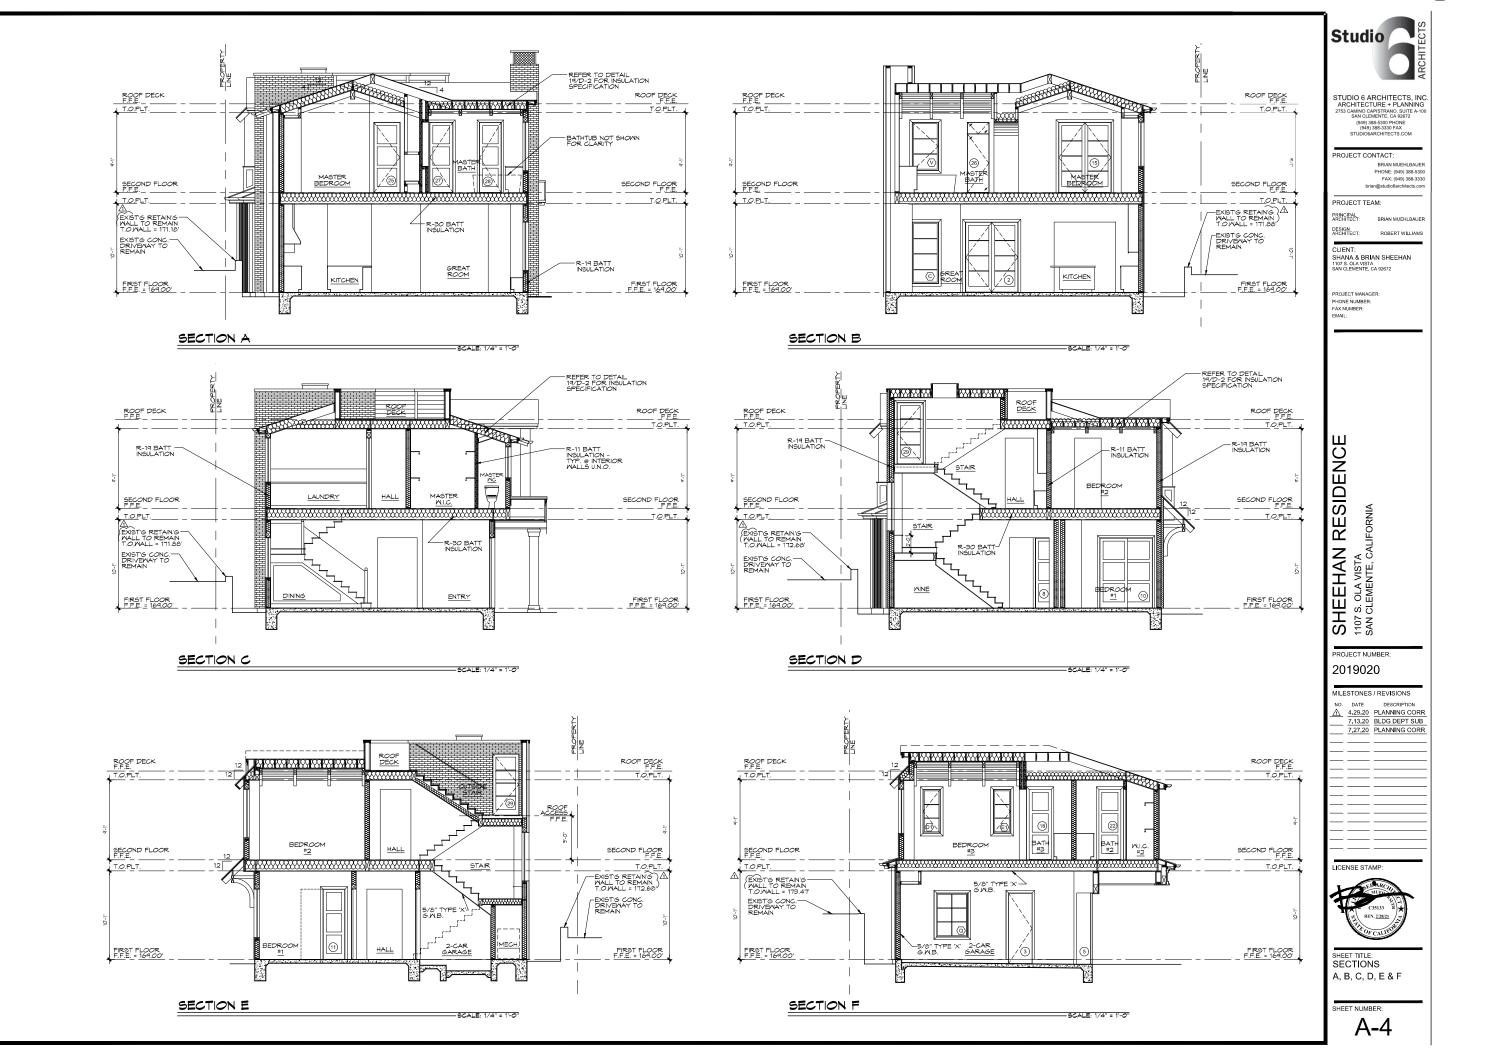



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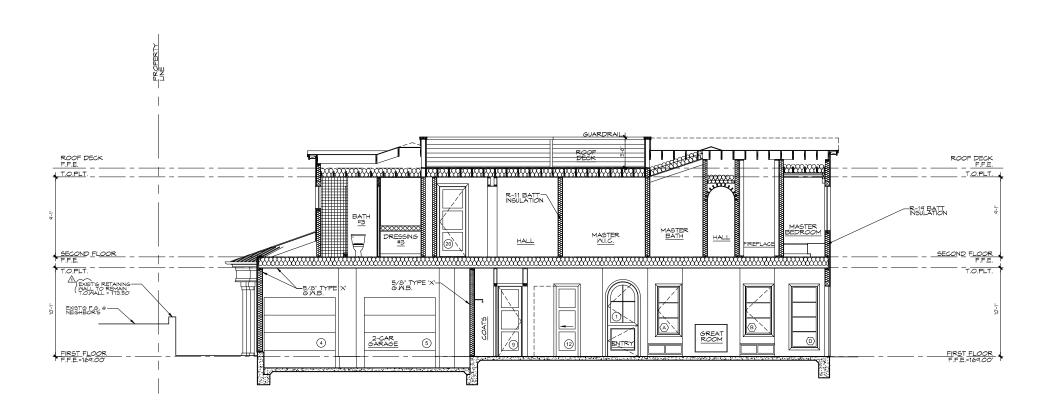
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SECTION H -SCALE: 1/4" = 1'-0"



STUDIO 6 ARCHITECTS, INC. ARCHITECTURE + PLANNING 2753 CAMINO CAPISTRANO, SUITE A-100 SAN CLEMENTE, CA 92672 (949) 388-5300 PHONE (949) 388-3300 FAX STUDIO6ARCHITECTS.COM

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PROJECT TEAM:

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SHEEHAN RESIDENCE 1107 S. OLA VISTA SAN CLEMENTE, CALIFORNIA

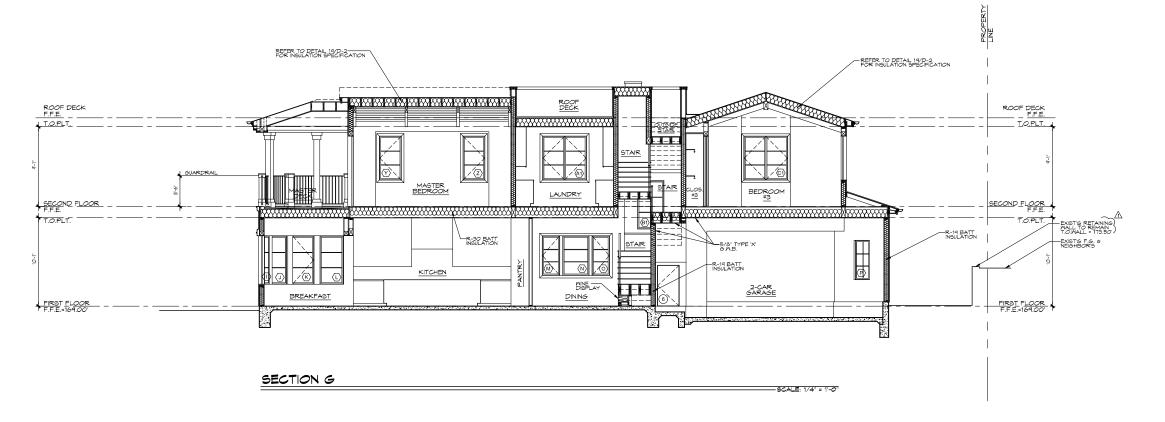PROJECT NUMBER: 2019020

MILESTONES / REVISIONS


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SHEET TITLE: SECTIONS G & H

SHEET NUMBER:

A-5



ROOF PLAN NOTES:

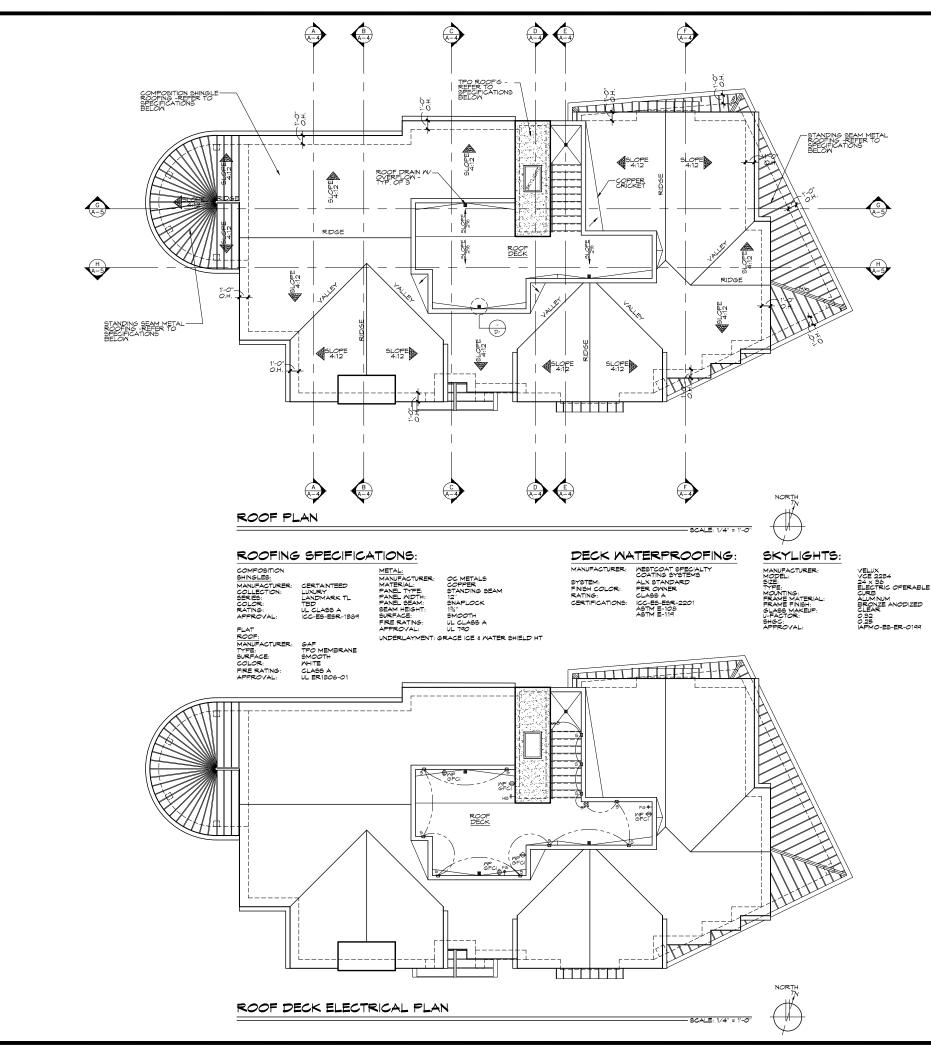1. DO NOT SCALE DRAWINGS.

2. INDICATES ROOF PITCH AS NOTED ON THE

ROOF PLAN.

3. ALL PLUMBING AND EQUIPMENT VENTS MUST BE CONSOLIDATED AND LOCATED IN AREAS THAT MINIMIZE THEIR VISIBILITY. VENTS MUST BE AS LOW IN HEIGHT AS

ALLOWED BY CODE. ALL FLASHING, SHEET METAL, VENT STACKS AND PIPES

4. ALL FLASHING, SHEET METAL, VENT STACKS AND PIP SHALL BE COPPER.
5. PROVIDE COPPER FLASHING AT ALL VALLEYS AND ROOF TO MALL CONDITIONS. REFER TO DETAILS.
6. IN "CALFORNIA" DOUBLE FRANING AREAS PROVIDE OFENINGS INTO MAIN ATTIC SPACE FOR ADEQUATE CONTRACTORY. VENTILATION.

IF "CALIFORNIA" DOUBLE FRAME AREA HAS MORE THAN

IF "CALIFORNIA" DOUBLE FRAME AREA HAS MORE THAN 30" HEADROOM PROVIDE A 20" X 30" MIN ACCESS THROUGH MAIN ROOF SHEATHING, VERIFY OPENINGS IN ROOF SHEATHING WITH STRUCTURAL ENGINEER.
 ALL BOX COLUMNS AND "POP-OUTS" SHALL REMAIN OPEN AT TOP FLATE LINE TO ALLOW FOR VENTILATION.
 AT ALL AREAS WITHIN THE ROOF ATTIC MITH 30" MIN. CLEAR HEADROOM, FROVIDE A 20" X 30" MIN. ATTIC ACCESS TO THOSE AREAS. ATTICS MITH APPLIANCES OR F.A.U UNITS INSTALLED IN THEM, PROVIDE A 30" X30" MIN. ATTIC ACCESS (FROVIDED F.A.U. MAY PASS THROUGH) MITH 30" MIN. CLEAR HEADROOM. PROVIDE WEATHER STRIPS AT PANEL TO PREVENT BACK DRAFT.

THROUGH) NITH 30" MIN. CLEAR HEADROOM, PROVIDE WEATHER STRIPS AT PANEL TO PREVENT BACK DRAFT.

10. PRIOR TO THE RELEASE OF THE ROOF SHEATHING INSPECTION, THE APPLICANT SHALL SUBMIT CERTIFICATION, BY A SURVEY OR OTHER APPROPRIATE METHOD, THAT THE HEIGHT OF THE STRUCTURES IS IN COMPLIANCE WITH THE ADOPTED APPROVAL RESOLUTION, AND THE HEIGHT LIMITATIONS (IF ANY) OF THE APPLICABLE ZONING DISTRICT.

THE APPLICABLE ZONING DISTRICT.

ALL ROOF EAVE GUTTERS SHALL BE 6" HALF-ROUND,
NON-EXTRUDED, CONTINUOUS COPPER WITH NO SEAMS.
ALL DOMNSFOUTS SHALL BE COPPER, 4" DIA, ROUND
WITH WELDED SEAMS, REFER TO ROOF FLAN AND
EXTERIOR ELEVATIONS FOR LOCATIONS.

12. COORDINATE CONNECTION OF CONTINUOUS ROOF EAVE GUTTERS AND DOWNSPOUTS TO ALLOW WATER TO FLOW AWAY FROM THE STRUCTURE. DOWNSPOUTS SHOULD BE CONNECTED TO CLOSED PIPES THAT DISCHARGE INTO SITE STORM DRAIN SYSTEM OR ONTO PAVED SURFACES THAT CARRY THE MATER AWAY AT LEAST 5'-0" FROM THE BUILDINGS FOUNDATION.

13. ANY FORCED AIR UNITS LOCATED IN THE ATTIC MUST BE . ANY FORCED AIR UNITS LOCATED IN THE ATTIC MUST BE POSITIONED IN SUCH A MANNER THAT THE REQUIRED DISTANCE FROM THE VENT OUTLET TO THE TOP OF THE FLUE CAP IS MITHIN THE ATTIC, ALLOWING THE EXTERIOR HEIGHT OF THE FLUE CAP ABOVE THE FINISHED ROOFING TO BE THE MINIMUM ALLOWED BY CODE. VENTING SHALL EXTEND ABOVE THE ROOF AND SHALL TERMINATION POINTS SHALL BETS ALL BEAST A SERT BE OWN OR MORIFICANTALLY FROM

BE AT LEAST 4 FEET BELOW OR HORIZONTALLY FROM BE AT LEAST 4 FEET BELOW OR HORIZONTALLY FROM AND 1 FOOT ABOVE ANY OPENING INTO THE BUILDING, BE AT LEAST 3 FEET ABOVE ANY FORCED AIR INLET INTO THE BUILDING LOCATED WITHIN 10 FEET, AND SHALL BE 4 FEET AWAY FROM THE PROPERTY LINE, PER 2019 C.M.C. AND 2019 C.P.C.

15. ROOF ELEVATIONS ARE TO TOP OF FINISHED MATERIAL.

TYP. U.N.O.

16. DS - DENOTES DOWNSPOUT LOCATION.

ATTIC VENTILATION NOTES:

PER 2013 C.R.C. SECTION R806 - ENCLOSED ATTICS FER 2013 C.R.C. SECTION R806 - ENCLOSED ATTICS
AND ENCLOSED SPACES FORMED WIBRE CEILINGS ARE
APPLIED DIRECTLY TO THE UNDERSIDE OF ROOF
RAFTERS SHALL HAVE A CROSS VENTILATION FOR EACH
SEPARATE SPACE BY VENTILATING OFENINGS
FROTECTED AGAINST THE ENTRANCE OF RAIN OR
SNOW, VENTILATION OPENINGS SHALL HAVE A LEAST SNOW, VENTILATION OFENINGS SHALL HAVE A LEAST DIMENSION OF ½, INCH MINIMUM AND ½, INCH MAXIMUM, VENTILATION OFENINGS HAVING A LEAST DIMENSION LARGER THAN ½, INCH SHALL BE FROVIDED MITH CORROSION-RESISTANT WIRE CLOTH SCREENING, HARDMARE CLOTH OR SIMILAR MATERIAL WITH OFENINGS HAVING A LEAST DIMENSION OF 1/16' MINIMUM AND 1/4" MAXIMUM, OPENINGS IN ROOF FRAMING MEMBERS SHALL CONFORM TO THE REQUIREMENTS OF SECTION R802.7.

MINIMUM VENT AREA THE MINIMUM NET FREE VENTILATING AREA SHALL BE $\chi_{\rm BO}$ of the area of vented space.

/ So OF THE AREA OF VENTED SPACE.

EXCEPTION:

THE MINIMUM NET FREE VENTILATING AREA SHALL BE
1/300 OF THE AREA OF VENTED SPACE PROVIDE ONE

OR MORE OF THE FOLLOWING CONDITIONS ARE MET:

1. IN CLIMATE ZONES 14 & 16, A CLASS | OR ||

VAPOR RETARDER IS INSTALLED ON THE

WARM-N-VINITER SIDE OF THE CEILING.

2. AT LEAST 40% AND NOT MORE THAN 50% OF

THE REQUIRED VENTILATING AREA IS PROVIDED

BY VENTILATORS LOCATED IN THE UPPER

PORTION OF THE ATTIC OR RAFTER SPACE.

UPPER VENTILATORS SHALL BE LOCATED NO PORTION OF THE ATTIC OR RAFTER SPACE. UPPER VENTILATORS SHALL BE LOCATED NO MORE THAN 3 FEET BELOW THE RIDGE OR HIGHEST POINT OF THE SPACE, MEASURED VERTICALLY, NITH THE BALANCE OF THE REQUIRED VENTILATION PROVIDED BY EAVE OR CORNICE VENTS. WHERE THE LOCATION OF WALL OR ROOF FRAMIG MEMBERS CONFLICTS WITH THE INSTALLATION OF UPPER VENTILATORS, INSTALLATION MORE THAN 3 FEET BELOW THE RIDGE OR HIGHEST POINT OF THE SPACE SHALL

ELECTRICAL PLAN NOTES:

NATES FIXTURE



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PROJECT TEAM

PRINCIPAL ARCHITECT: DESIGN ARCHITECT

ROBERT WILLIAMS

CLIENT: SHANA & BRIAN SHEEHAN 1107 S. OLA VISTA SAN CLEMENTE, CA 92672

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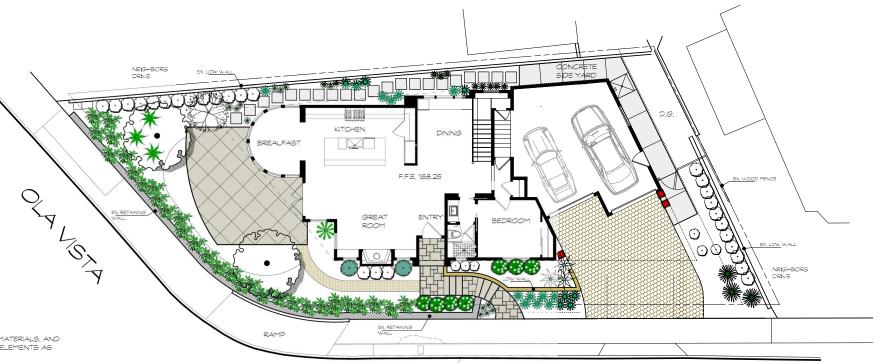
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ROOF PLAN & ROOF ELECTRICAL PLAN

SHEET NUMBER:

A-6



THE CONTRACTOR SHALL PROVIDE ALL LABOR, TRANSPORTATION, MATERIALS, AND SERVICES NECESSARY TO FURNISH AND INSTALL ALL CONSTRUCTION ELEMENTS AS SHOWN ON THE DRAWINGS AND SPECIFIED HEREIN.

- 2. ALL WORK SHALL BE PERFORMED BY A CALIFORNIA LICENSED CONTRACTOR.
- 3. CONSTRUCTION AND INSTALLATION OF ALL LANDSCAPE ITEMS SHALL BE ACCORDING TO STATE, COUNTY AND LOCAL CODES, ORDINANCES AND UP TO CAL-OSHA SAFETY ORDERS REGARDING PERFORMANCE OF WORK.
- 4. THE CONTRACTOR SHALL BE RESPONSIBLE FOR FAMILIARIZING THEMSELVES WITH THE NATURE AND LOCATION OF ALL UNDERGROUND UTILITIES, PIPES AND STRUCTURES. THE CONTRACTOR SHALL TAKE SOLE RESPONSIBILITY FOR ALL COSTS INCURRED DUE TO DAMAGE AND / OR REPLACEMENT OF SAID UTILITIES, INCLUDING DELAYS.
- 5. ANY DISCREPANCIES BETWEEN THE FIELD CONDITIONS AND THE CONTRACT DOCUMENTS AND / OR THE DESIGN INTENT AFFECTING THE SUCCESSFUL COMPLETION AND COST OF THE PROJECT SHALL BE REPORTED TO THE OWNER (JOB SUPERINTENDENT), AND LANDSCAPE ARCHITECT IMMEDIATELY, ALL WORK RELATED TO THE PROBLEM AREA SHALL CEASE UNTIL THE DISCREPANCIES HAVE BEEN RESOLVED BY THE OWNER (JOB SUPERINTENDENT) OR ANDSCAPE ARCHITECT IN WRITING. ANY CONTINUATION OF WORK PRIOR TO THE RESOLUTION OF DISCREPANCIES IS AT THE CONTRACTOR'S RISK AND EXPENSE.
- 6. NO WORK SHALL BE PERFORMED WITHIN THE PUBLIC RIGHT-OF-WAY BY THE APPLICANT / OWNER, OR THEIR AGENTS UNTIL A PUBLIC PROPERTY ENCROACHMENT PERMIT IS ISSUED BY THE CITY ENGINEER
- . CONTRACTOR SHALL INSTALL THIS PROJECT IN ACCORDANCE TO ALL CITY CODES AND A. CONTRACTOR SHALE INSTRUCTED IN ACCURANCE TO ALL OTHER CODES AND REQUIREMENTS. CONTRACTOR SHALL BRING TO THE ATTENTION OF THE OWNER AND THE LANDSCAPE ARCHITECT PRIOR TO CONSTRUCTION ANY KNOWN DISCREPANCY BETWEEN THAT WHICH IS SPECIFIED ON THESE PLANS AND THAT WHICH IS PERMITTED BY GOVERNING CODES AND THE HOME OWNERS' ASSOCIATION.
- 8. WITH THE ACCEPTANCE TO CONSTRUCT THIS PROJECT, CONTRACTOR AND OWNER AGREE TO HOLD LANDSCAPE ARCHITECT HARMLESS OF ANY UNFORESEEN CONSTRUCTION COSTS DUE TO ELEMENTS NOT SPECIFIED ON THESE PLANS.
- 9. IT IS THE RESPONSIBILITY OF THE CONTRACTOR TO VERIEY ALL SITE CONDITIONS PRIOR TO COMPLETING BIDS. CONTRACTOR SHALL INCLUDE IN THEIR BID THE COST OF ALL DEMOLITION AND ANY SOIL IMPORT AND OR EXPORT NEEDED TO COMPLETE THIS PROJECT
- 10. CONTRACTOR SHALL INSTALL THIS PROJECT UTILIZING THE LANDSCAPE INDUSTRIES'S B. M. P. BEST MANAGEMENT PRACTICES.

PASEO DE CRISTOBAL

SECTION 4216/4217 OF THE GOVERNMENT CODE REQUIRES A DIG ALERT IDENTIFICATION NUMBER BE ISSUED BEFORE A PERMIT TO EXCAVATE WILL BE VALID. FOR YOUR DIG ALERT IDENTIFICATION

TOLL FREE 1-800-422-4133



UNDERGROUND SERVICE ALERT OF SOUTHERN CALIFORNIA

NOTICE TO HOMEOWNER: HOME OWNER SHALL PROCESS PLANS THROUGH THE HOME OWNER'S ASSOCIATION PRIOR TO ANY CONSTRUCTION. ISSUANCE OF A BUILDING PERMIT BY THE CITY DOES NOT RELIEVE THE APPLICANT OF LEGAL REQUIREMENT TO OBSERVE COVENANTS, CONDITIONS, AND RESTRICTIONS WHICH MAY BE RECORDED AGAINST THE PROPERTY OR TO OBTAIN COMMUNITY ASSOC, APPROVAL.

SHEET INDEX:

- L-1 COVER SHEET
- L-2 CONSTRUCTION PLAN
- L-3 CONSTRUCTION DETAILS
- L-4 LIGHTING PLAN
- L-5 IRRIGATION PLAN
- L-6 IRRIGATION DETAILS
- L-7 IRRIGATION DETAILS
- L-8 PLANTING PLAN
- L-9 IRRIG. & PLANTING SPECS.

DATE: 7-27-20 DRAWN BY: D.P.

SHEET NO.

OF - 9

GENERAL NOTES AND SPECIFICATIONS

1. GENERAL NOTICE TO CONTRACTORS
ALL CONTRACTORS AND SUBCONTRACTORS PERFORMING WORK SHOWN ON OR RELATED TO THESE PLANS SHALL
CONDUCT THEIR OFERSTRIONS SO THAT ALL EMPLOYEES ARE PROVIDED A SAFE PLACE TO WORK AND THE PUBLIC IS
PROTECTED. ALL CONTRACTORS AND SUBCONTRACTORS SHALL COMPLY WITH THE OCCUPATIONAL SAFETY AND
HEALTH REGULATIONS OF THE US DEPARTMENT OF LABOR, AND WITH THE STATE OF CALIFORNIA DEPARTMENT OF
INDUSTRIAL RELIATIONS "CONSTRUCTION SAFETY ORDERS". THE OWNER AND OWNERS REPRESENTATIVES SHALL NOT BE
RESPONSIBLE IN ANY WAY FOR THE CONTRACTORS AND SUBCONTRACTORS COMPLIANCE WITH SAID REGULATIONS AND
OPPERS.

RESPONSIBLE IN ANY WAY FOR THE CONTRACTORS AND SUBCONTRACTORS COMPLIANCE WITH SAID REGULATIONS AND ROBERS.
CONTRACTOR FURTHER AGREES THAT HE SHALL ASSUME SOLE AND COMPLETE RESPONSIBILITY FOR JOB SITE CONDITIONS DURING THE COURSE OF CONSTRUCTION OF THE PROJECT, INCLUDING SAFETY OF ALL PERSONS AND PROPERTY. THAT THIS REQUIREMENT SHALL APRLY CONTINUOUSLY AND NOT BE LIMITED TO NORMAL WORKING HOURS, AND THAT THE CONTRACTOR SHALL DEFEND, INDEMNITY AND HOLD THE OWNER AND HIS REPRESENTATIVE HARPLESS FROM ANY AND ALL LABILITY, REAL OR ALLEGED, IN CONNECTION WITH THE PERFORMANCE OF WORK ON THIS PROJECT, EXCEPTING FOR LIABILITY ARISING FROM THE SOLE NEGLIGIBLICS OF THE OWNER OR HIS REPRESENTATIVE. IT SHALL BE THE CONTRACTORS RESPONSIBILITY OF AGREETANT HE LOCATION OF ALL UNDERGROUND UTILITIES OR STRUCTURES FROM FIELD INVESTIGATIONS AND AVAILABLE RECORDS PRIOR TO COMMENCING ANY EXCAVATION.

2. CONCRETE AND REINFORGING STEEL

2 CONCRETE AND REINFORCING STEEL.

CEMENT FOR CONCRETE SHALL BE A STANDARD BRAND MEETING THE REQUIREMENTS FOR TYPE V CEMENT OF ASTM
SPECIFICATIONS C.150. "PORTLAND CEMENT."
MINIMUM COMPRESSIVE STRENGTH OF ALL CONCRETE SHALL BE 2,500 PSI N 28 DAYS. 6 SACK MIX WITH A 5" MAX.
SLUMP, AT A MINIMUM HICKNESS OF FOUR INCHES OVER 1" SAND BASE AND 90% COMPACTED NATIVE SOIL. (DRIVEWAY
MIX. THEXNESS OF 6 INCHES)

THE LARGEST PRACTICAL SIZE OF COARSE AGGREGATE UP TO 1/2" SHALL BE USED IN THE CONCRETE.

MINIMUM CONCRETE CLEAR COVERAGE OF REINFORCING STEEL SHALL BE AS FOLLOWS:

BERUKS PLASING THE CONCRETE. BRINFORCHS STEEL SHALL BE SECURELY TIED IN PLACE WITH HIS DOUBLE ANNEALED STEEL WIRE. BARS SHALL BE SUPPORTED ON WELL-CURED CONCRETE BLOCKS OR APROVED METAL CHARS. WIRE FASRIC SHALL CONCRIM TO STANDARD SPECIACIONS FOR WELD WIRE FASRIC FOR CONCRETE REINFORCEMENT, 'ASTM A-185-64"

ALL CONCRETE WORK SHALL RECEIVE 1/2" FIBERMIK STEALTH MULTIFILAMENT FIBERS" AT 2 LBS. PER CU. YE ALL CONCRETE FLAT WORK. AND OR STONE SUB-BASE SHALL RECEIVE. NO. 3 BAR AT 18 INCHES ON CENTER, CHAIRED IN

PLACE ALONG CENTER OF SLAB. PLACE ALONG CENTER OF SLAC. DRIVE CONCRETE FLAT WORK SHALL RECEIVE NO. 4 BAR AT 12 INCHES ON CENTER, CHAIRED IN PLACE ALONG CENTER OF

DAVE CONCRETE SHALL BE A MINMUM THICKNESS OF 8 INCHES.

ALL CONCRETE SHALL BE A MINMUM THICKNESS OF 8 INCHES.

ALL CONCRETE SHALL BE UNDESLAIN WITH A VAPOR BARRIER CONSISTING OF A PLASTIC FILM (TEN ML POLYVINY).

CHLORIDE OR EQUIVALENT) AT A MINMUM. THE VAPOR BARRIER SHOULD BE PROPERLY LAPPED AND SEALED. SINCE THE VAPOR BARRIER WILL PREVENT MOISTURE FROM DRAINING FROM FRESH CONCRETE, A BETTER CONCRETE FINISH CAN USUALLY BE OBTAINED IF AT LEAST TWO INCHES OF SAND IS SPREAD OVER THE VAPOR BARRIER PRIOR TO PLACEMENT OF CONCRETE.

3. MAGONRY.

UNIT MASONRY SHALL CONFORM TO THE REQUIREMENTS OF ASTM C-90 GRADE N. MINIMUM COMPRESSIVE STRENGTH
SHALL BE FOR THE GROSS SECTION OF BLOCK.

CEMENT FOR MASONRY MORTAR SHALL CONFORM TO THE REQUIREMENTS OF ASTM C-150 PORTLAND CEMENT, TYPE I,
MORTAR SHALL BE 19 (ZEMENT AND SAND MIX WITH 1/4 PART APPROVIED HYDRATED LIME OR LIME PUTTY, TYPE M OR S.
GROUT SHALL BE 19 CEMENT, SAND, AND 3/6 'PEA GRAVEL MIX WITH A SLUMP OF 6' TO IT.

DRYPACK SHALL BE 19 CEMENT AND SAND MIX.

ALL RENFORCING STEEL SHALL BE INTERMEDIATE GRADE PERFORMED BARS CONFORMING TO ASTM A-6'S, GRADE 40.

RENFORCING STEEL SHALL BE LOCATED AT THE CENTER OF THE WALL UNLESS OTHERWISE NOTED ON THE PLANS, I.E.

RETAINING WALLS.

SPLICES OF RENFORCING STEEL SHALL LAP 40 DIAMETERS OR 2-0' MINIMUM.

ALL RENFORCING STEEL, ANCHOR BOLTS, DOWELS AND OTHER INSERTS SHALL BE SECURELY ANCHORED IN PLACE
PRIOR TO GROUT.

PROJECT HARDSCAPE MATERIALS:

RAISED PLANTER WALL SHALL BE FACED WITH COUGAR STONE NORTHWINDS SAWN BLUE

ALL WALL CAR SHALL BE BY PACIFIC STONE DESIGN INC. 866-997-8663. TRESTLES SAND TEXTURE, COLOR #30 USE CUSTOM CORNERS AND RADIUS - NOT MITERED.

COLORED CONCRETE SHALL BE BY DAVIS COLORS (860) COBBLESTONE'. CONTRACTOR SHALL SUBMIT CONCRETE COLOR SAMPLE FOR APPROVAL. TOP CAST SURFACE RETARDER #3 FINISH.

CONTACT VON ARONGON OF HAEARTWOOD CREATIONS FOR CONSTRUCTION ALL WOOD FENCES AND GATES 949-464-1951.

GENERAL:

GENERAL:
CONTRACTOR SHALL PROVIDE DECK-0-SEAL EXPANSION MASTIC (COLOR TO MATCH ADJACENT HARDSCAPE,
FINSHED WITH SILICA SAND AS EXPANSION JOINTS, EXPANSION JOINTS SHALL OCCUR AT BOTTOM OF STEPS,
CHANGE IN DIRECTION OF CONCRETE WALKS, ADJACENT TO BULDINGS, AND WHERE NEW CONCRETE PAYING
ABUTE EXPANTS SIDEWALKS AND / OR CURBS. THE RECOMMENDED SPACING FOR EXPANSION JOINTS IN WALK
IS 16 FT. O.C. FOR CONTINUOUS WALKS UNLESS OTHERWISE RECOMMENDED BY SOLS ENGINEER.

ALL INSIDES OF ALL RAISED PLANTERS / RETAINING WALLS SHALL RECEIVE THOROSEAL WATERPROOFING PER MANUFACTURES SPEC.

CONTRACTOR SHALL CONSULT OWNER IN REGARDS TO OUTDOOR SPEAKER LOCATION. AND PROVIDE SEPARATE BID FOR RUNNING SPEAKER WIRE IN PVC SCH 80 CONDUIT AND WIRE TO EACH LOCATION.

CONTRACTOR SHALL PROVIDE OWNER AS BUILT DRAWINGS FOR ALL UNDERGROUND UTILITIES - IRRIGATION WIRES, ANY SPEAKER WIRES AND OR GAS LINES.

ALL TREES PLANTED WITHIN FIVE FEET OF HARDSCAPE SHALL HAVE A ROOT BARRIER DEVICE INSTALLED ADJACENT TO HARDSCAPE AREA.

ALL DOWNSPOUTS SHALL BE CONNECTED TO THE LOT DRAINAGE SYSTEM. SEE DRAINAGE PLAN

CONTRACTOR SHALL BE IN CHARGE OF PROCESSING ALL PERMITS WHERE NEEDED.

POOLS, SPAS, WALLS, FENCES, PATIO COVERS, AND OTHER FREE-STANDING STRUCTURES REQUIRE SEPARATE REVIEWS AND PERMITS.

NO WORK SHALL BE PERFORMED WITHIN THE PUBLIC RIGHT-OF-WAY BY THE APPLICANT / OWNER, OR HIS OR HER AGENTS UNTIL A PUBLIC PROPERTY ENCROACHMENT PERMIT IS ISSUED BY THE CITY ENGINEER.

MASONRY CONTRACTOR SHALL COORDINATE WITH DRAINAGE CONTRACTOR, IRRIGATION CONTRACTOR AND ELECTRICIAN TO ENSURE THAT ALL SLEEVES AND CROSSINGS ARE PROVIDED PRIOR TO PLAQING OF PAVING CONCRETE, ETC.

ALL CONSTRUCTION SHALL CONFORM TO ALL LOCAL CODES AND ORDINANCES.

FINISH SURFACE OF CONCRETE OR HARDSCAPE SURFACE TO BE A 3' MINIMUM BELOW STUCCO SCREED, VERIFY IN FIELD AND ADUST GRADES IF NECESSARY TO ACHEVE THIS. CHECK WITH GOVERNING CODES FOR REQUIREMENTS AND COMPLY WITH IF DIPPERENT.

STEP TREADS TO BE 12' WIDE MINIMUM.

CONTRACTOR SHALL INSTALL THIS PROJECT IN ACCORDANCE TO ALL CITY CODES AND REQUIREMENTS CONTRACTOR SHALL BRING TO THE ATTENTION OF THE OWNER AND THE LANDSCAPE ARCHITECT PRIOR TO CONSTRUCTION. ANY KNOWN DECREPANCY BETWEEN THAT WHICH IS SPECIFIED ON THESE PLANS AND THAT WHICH IS PERITITED BY GOVERNING CODES AND THE HOME OWNERS ASSOCIATION.


WITH THE ACCEPTANCE TO CONSTRUCT THIS PROJECT, CONTRACTOR AND OWNER AGREE TO HOLD LANDSCAPE ARCHITECT HARMLESS OF ANY UNFORESEEN CONSTRUCTION COSTS DUE TO ELEMENTS NOT SPECIFIED ON

IT IS THE RESPONSIBILITY OF THE CONTRACTOR TO VERIFY ALL SITE CONDITIONS PRIOR TO COMPLETING BIDS. CONTRACTOR SHALL INCLUDE IN THEIR BID THE COST OF ALL DEMOLITION AND ANY SOIL IMPORT AND OR EXPORT NEEDED TO COMPLETE THIS PROJECT.

CONSTRUCTION BID ITEMS:


CONTRACTOR SHALL PROVIDE AN ITEMIZED BID COST FOR EACH OF THE FOLLOWING

- (1) STONE STEPS WITH RISER TO BE STACKED STONE, TREAD TO BE CUSTOM ROCK EDGE BLUESTONE. SEE LIGHTING PLAN FOR LIGHTS IN STEPS.
- (2) COBBLE STONE DRIVE WITH 6' THICK CONCRETE BAGE. SHADOW GRAY 6 X 6 COBBLE AS SUPPLIED BY COUGAR STONE.
- (3) DECOMPOSED GRANITE PATH, THREE IN THICK MIN. OVER FILTER FABRIC. EDGE WITH PERMALOCK LANDSCAPE EDGING.
- $oldsymbol{4}$ random square and rectangle stone hardscape, slope to drain. Grout shall be tight and uniform $\pm 1/2$.
- (5) COLORED CONCRETE HARDSCAPE WITH CONTROL JOINTS AS SHOWN AND EXPANSION JOINT AT HOUSE.
- $oldsymbol{6}$ STONE FACED LANDSCAPE WALL $\pm 36^\circ$ HIGH, CAP THIS WALL WITH PRE CAST CONCRETE CAP.
- $\left(oldsymbol{7}
 ight)$ concrete hardscape with control joints as shown and expansion joint at house.
- $m{(a)}$ FILL IN GAP IN EXISTING WALL. USE BLOCK FROM WALL SECTIONS THAT ARE TO BE REMOVED.
- (9) COLORED CONCRETE STEPPING PADS, ALLOW ±6" BETWEEN EACH FOR PLANTING.
- $oldsymbol{(0)}$ OUTDOOR SHOWER DRAIN LOCATION (BY HOME BUILDER).
- (1) 6 FT HORIZONTAL WOOD SIDE YARD GATE.
- (12) 3/16 PERMALOC LANDSCAPE EDGING.
- (3) EXISTING WOOD FENCE TO REMAIN.
- (14) EXISTING WALL, TO REMAIN

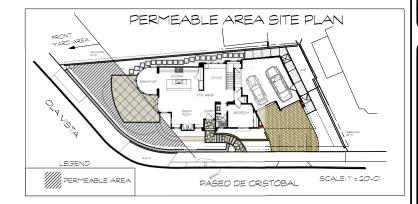

TOTAL FRONT YARD AREA = 810

512 SQ. FT. PERMEABLE which is = to 63% of the total area. (MIN. 50% REQUIRED) 298 SQ. FT. IMPERMEABLE which is = to 37% of the total area.

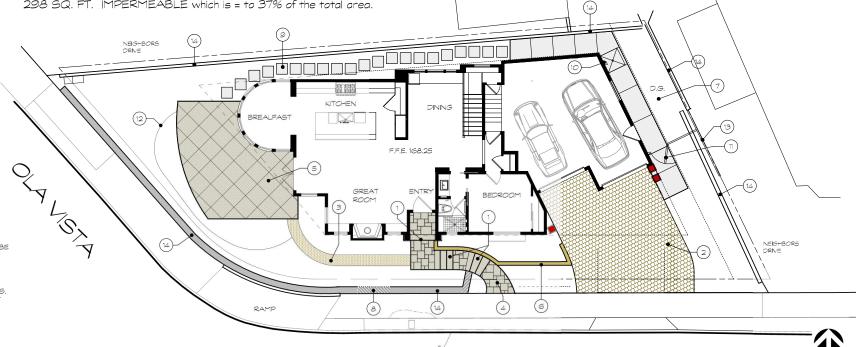

PASEO DE CRISTOBAL

ALL WORK RELATED TO WATER IN THE PUBLIC RIGHT-OF-WAY SHALL BE PERFORMED BY A C-34 LICENSED PIPELINE CONTRACTOR OR AN A LICENSED GENERAL ENGINEERING CONTRACTOR.

ISSUANCE OF A BUILDING PERMIT BY THE CITY OF DOES NOT RELIEVE APPLICANTS OF THE LEGAL REQUIREMENTS TO OBSERVE COVENANTS CONDITIONS AND RESTRICTIONS WHICH MAY BE RECORDED AGAINST THE PROPERTY OR TO OBTAIN PLANS. YOU SHOULD CONTACT YOUR COMMUNITY ASSOCIATION PRIOR TO COMMENCEMENT OF ANY CONSTRUCTION AUTHORIZED BY THIS PERMIT

PRIOR TO PERFORMING ANY WORK IN THE CITY RIGHT-OF-WAY AN ENCROACHMENT PERMIT MUST BE OBTAINED FROM THE PUBLIC WORKS DEPARTMENT

SCALE: 1/8" = 1-0"

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PLANS CAPE ARCHITECTURAL P HANA AND BRIAN SHEE 5. OLA VISTA • SAN CLEMENTE, O PH. (949) 350-2207

CAPE

DATE: 7-27-20

DRAWN BY: D.P. SHEET NO.


1. CLINCH TIE OR EQUAL (4 REQ'D)

- 2. 10 LODGE POLE STAKES, STAKE SHALL CLEAR ROOT BALL BY 2'
- 3. VENTILATED TRUNK GUARD IN TURF AREAS
- 4. TOP OF ROOT BALL TO BE 11/2" ABOVE FINISH GRADE.

- 6. 2" THICK MULCH LAYER, PER SPEC.
- 7. FERTILIZER & MYCORRHIZAE TABS (SEE SPECS.)
- 8. ROUGHEN SURFACE OF ROOT BALL

TREE PLANTING DETAIL

NOTE: ALL TREES PLANTED WITHIN FIVE FEET OF HARDSCAPE SHALL HAVE A ROOT BARRIER DEVICE INSTALLED ADJACENT TO HARDSCAPE AREA.

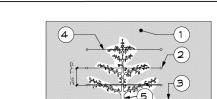

SPECIMEN TREE PLANTING DETAIL

LEGEND

(10)

LEGEND

1 SPECIMENT YEEE, SE BOY OR LARGER

2 BLACK AND HOSE WITH 18 BRAIDED SALVANIED STEEL GUY CABLE, USE GANANIED

CABLE LAMPS AND TILKROUGH, HIMMIN'S GUYS.

3 I ZO AN 2 I LOWS WHITE PLY QUARNIED SEVELE TO BE INSTALLED IN PUBLIC AREAS,

3 WATER BRAIN HIMMIN'S ADDITION DEVICE TO BE INSTALLED IN PUBLIC AREAS,

5 FINAN BRAIDE, CROWN OF TIRE MUST NOT BE FLANTED BELOW THE LARGE.

5 FINAN BRAIDE, CROWN OF TIRE MUST NOT BE FLANTED BELOW THE LARGE.

6 ANYTHOUGH DEVICINIENT AS SERVICE MUST AND SETTLE SHOCKLE, BEFORE PLANTINGS 50 THAT TIRE DOES NOT SINK AFTER PLANTINGS. SOTTOM THE DOES NOT SINK AFTER PLANTINGS.

TITER ROOTBALL - HUST NOT BE ROOT BOUND, LOOSEN ANY TIEMT PRICKED ROOTS.

AIR AND WATERING PLACE MIN. 3 PER TREE. 9. FERTILIZER TABLETS - SEE SPECIFICATIONS

10. MODEL 68 DUCKBILL EARTH ANCHOR WITH 16' BRAIDED GALVANIZED STEEL CABLE. INSTALL PER MFG. SPECIFICATIONS.

11. ROOTBALL DEPTH PLUS & FOR WASHED SAND

NOTE: ALL TREES PLANTED WITHIN FIVE EEET OF HARDSCAPE SHALL HAVE A ROOT

12. 12' Ø AUGURED HOLE X 6' DEEP FILL WITH WASHED SAND.

IF BEDROCK IS ENCOUNTERED DIG AN ADDITIONAL 18"

8. EMPTY 3' DIAMETER PERFORATED PVC DRAIN PIPE FOR

LEGEND

- 2. EYEBOLTS: 3/8" DIA EYEBOLTS IN LEAD SHIELDS, PROVIDE 6.
 3. FINISH GRADE
 4. 12 GA GALV. WIRE: SECURE VINE TO WIRE WITH
- NURSERYMANS TAPE.

 5. ANGLE TRUNK OF VINE BACK TO WALL AND REMOVE STAKE & TIE.

NOTE: WHEN PLANTING SEVERAL VINES ON ONE WALL, WIRE TRELLIS SHALL BE CONTINUOUS.

NON-ADHERING TYPE

ELEVATION

- WALL OR FENCE
 EYEBOLTS: 3/8" DIA EYEBOLTS IN LEAD SHIELDS,

VINE DETAIL

- Turf area does not exceed 25% of landscape planting area (prohibited on slope areas and parkways less than 10 feet wide)
- 75% of landscape area must be plated with climate adapted plants with an average WUCOLS plant factor of 0.3.
- Compost at a rate of four cubic yards per 1,000 square feet to a depth of six inches

3-inch mulch layer applied to all planting areas (excluding turf areas) Automatic irrigation controllers with manual shut-off valves

Statement, "Owner to agree to comply with the requirements of the prescriptive compliance option to the MWELO)." D Peders M

SYMBOL BOTANICAL NAME

COMMON NAME

DESCRIPTION

SPACING DESCRIPTION

SIZE DESCRIPTION
60 BOX OPEN BRANCHING TREE TO 20 FT, WITH BLUE GREEN FOLIAGE TAKES PRUNING WELL

THE POLLOWING IS A COMPUTERIZED COUNT OF ALL SHRUBS.
CONTRACTOR SHALL VERBY THE FOLLOWING PLANT TOTALS AN
NOTIFY THE LANDSCAPE ADMITTED OF ANY DECERBANCES
BETWEEN THE NUMBER OF RANTS SHOWN ON THE PLAN AND TH
TOTALS LISTED HERE ON.

W	AND THE	
	SHRUBS	
7	SYMBOL	BOTANICAL NAME
	AEO-URB	BOTANICAL NAME AEONIUM URBICUM

SYMBOL	QUANTITY	STRIBUL	BOTANICAL NAME
AEO-URB	7	AEO-URB	AEONIUM URBICUM
CRA-UND	12	CRA-UND	CRASSULA UNDULATIFOLIA 'BLUE WAVE
ELA-DEC	1	ELA-DEC	ELAEOCARPUS DECIPIENS MONPROUGLITTLI
CITRUS	1	DWARF C	ITRUS - OWNER TO SELECT VARIETY
GER-SD	30	GER-SID	GERANIUM SIDIOIDES
HEL-ARB	1	HEL-ARB	HELIOTROPIUM X MARINE
LAV-OTT	3	LAV-OTT	LAVANDULA STOECHAS OTTO QUAST
<u> </u>	17	MUH-RIG	MUHLENBERGIA RIGENS
OLE-DWF	9	OLE-DWF	OLEA EUROPAEA MONTRA
OST-BAR	4	OST-BAR	OSTEOSPERMUM BARBERIAE COMPACT
PEN-HYB	3	PEN-HYB	PENSTEMON HYBRID
RAP-MIN	22	RAP-MIN	RAPHIOLEPIS UMBELLATUS MINOR
ROS-ICE	8		ROSA ICEBERG (CLIMBER WHEN SPECT
ROS-IRE	49	ROS-IRE	ROSMARINUS P. 'IRENE'
SAL-LEU	5		SALMA LEUCANTHA
WIS-ROS	2	WIS-FRU	WISTRINGIA FRUTICOSA GREY BOX

GROUND COVER

SYMBOL BOTANICAL NAME

CAR-TUM CAREX TUMULICOLA

QUAST	SPANISH LAVENDER	FIVE (
	DEER GRASS	FIVE (
	LITTLE OLLIE DWF OLIVE	15 GA
COMPACTUM	1PURPLE MOUNTAIN SUN DAISY	ONE (
	PENSTEMON	ONE (
NOR"	DWARF YEDDA HAWTHORNE	15 GA
EN SPECT.)	ICEBERG ROSE	FIVE (
	PROSTRATE IRENE ROSEMARY	ONE (
	MEXICAN SAGE	FIVE (
BOX	DWARF WESTRINGIA	15 GA

COMMON NAME

BERKELEY SEDGE

SALAD BOWL AEONIUM PIVE GAL. LARGE GREEN SUCCULENT LEAVES IN ROSETTS UP TO 2 PT. ACROSS REGULAR WATERING 3 PT. WIDE BY 18' TALL.

VE. BLUE WAVE RIPPLE JADE PIVE GAL. COMPACT DENSE SMALL SUCCULENT TO 3FT. W. TWISTED BLUBH GREY LEAVES.

TLE EMPEROR JAPANESE BLUESERRY 24' BOX UPRIGHT EVERGREEN SHUB TO 8 FT. WITH GLOSSY GREEN FOLIAGE THAT TURNS BRIGHT RED BEFORE DROPPING. CRIMSON & GREY GERANIUM ONE GAL. DENSE GROUND COVER TO 12" WY ROSE-PINK BLOGGOMS, FULL SUN SOFT BLUE GREY FOLIAGE TIME GAL. SUB-TROPICAL EVERGREEN SHRUB TO 30 W/ DEEP DARK GREEN LEAVES W/ COBALT BLUB FLOWERS.
TIVE GAL. GRAY-GREEN FOLIAGE PERENNAL TO 2-3 FT. SHOWY PURPLE BRACKS EA. TOPPED W/ TUFT OF LARGER PURPLE PETAL LIKE BRACK GAL, CALP, NATIVE BUNCH GRASS TO 3 FT. W. NARROW GRAY-GREEN LEAVES AND LONG SILVER-GRAY FLOWER ABOVE PLANT.

AL. DWARF OLIVE TO 3 FT. WITH BLUE GREEN FOLIAGE TAKES PRUNING WELL.

5 GAL, LAVENDEZ-PURZIE, D'AGIES ON A COMPACT MOUNDING SHRUB TO 2 FT.

5 GAL PERENNIAL W. MANY STEMS TO 16 W. LANCE SHAPED DARK GREEN LEAVES TOPPED W. FLOWER SPIKES TO 30'

14. SLOW GROWING COMPACT URGIGHT SHRUB TO 4 FT W. WHITE FLOWER CLUSTERS.

5 GAL PROFUSE WHITE BLOOMING ROSE, EXCELENT ON FENCES. (CLIMBING WHERE SPECIFIED)

PLUGS AT 12' O.C. CALIFORNIA NATIVE GROUND COVER.

GAL, AROMATIC BLUE GREEN FOLLAGE PROSTRATE GROWING SHEED WUDEP BLUE-VIOLET FLOWER SPIKES, FULL SUN.
GAL, MOUNDING 3 FT. SHRUB LONG SLENDER VELVETY PURPLE SPIKES W/ SMALL WHITE FLOWERS.
AL. EVERGREEN SHRUB TO 5 FT. WITH SMALL WHITE FLOWERS AND ROSEMARY LIKE FOLLAGE.

EDGE OF PLANTING

NOTE: ALL MASS PLANTED SHRUBS AND GROUND COVER SHALL BE PLANTED AT EQUAL SPACING (TRIANSULAR) UNLESS OTHERWISE INDICATED ON PLANS. SEE LEGEND FOR SPACING REQUIREMENTS. MULCH ALL PLANTING AREAS PER SPEC.

GROUND COVER AND SHRUB SPACING

3

- A All planted landscape areas are required to have friable soil to maximize retention and infiltration. On engineered slopes, only amended planting holes need meet
- B. In order to reduce runoff and encourage healthy plant growth, a soil management report shall be completed by the project applicant, or his/her designee, as follows: 1. Submit soil samples to a certified agronomic soils laboratory for analysis and recommendations.

 (a) Soil sampling shall be conducted in accordance with aboratory protocol, includina protocols regarding adequate sampling depth for the intended plants.
 (b) The soil analysis may include, but is not limited to:
- solltexture;
 infiltration rate determined by laboratory test or soil texture infltration rate table;
- 3. pH; 4. total soluble salts;
- 6. percent organic matter; and
- Soil Preparation Mulch and Amendments
 (a) Prior to planting of any materials, compacted soils shall be transformed to a friable condition. On engineered slopes, only amended planting hales need to meet this requirement (b) Soil amendments shall be incorporated according to the recommendations of the soil report and what is appropriate for plants selected.
 (c) For landscape installations, compost at a rate of a minimum
- of four cubic yards per 1.000 square feet of permeable area shall be incorporated to a depth of six inches into the soil.


 Soils with greater than 6% organic matter in the top 6 inches of soil are exempt from adding compost and tilling.

 (d) A minimum two, three inch (3°) layers of mulch shall be (a) A limitation we, the entant of planting areas we except in turf areas, creening or rooting groundcovers, or direct seeding opplications where mulch is controllational. To provide habitat for beneficial insects and other wildlife, up to 5% of the landscape are may be left without mulch. Designated insect habitat must be included in the landscape design plan as such.

 (e) Stabilizing mulching products shall be used an slapes that
- meet current engineering standards such as those detailed in the USDA/USAID Low Volume Roads Engineering Best
- in the USSN SAIN book Volume Sous Significanting Desi Management Practices Field Guide. (f) The mulching portion of the seed/mulch slurry in hydroseeded opplications shall meet the mulching requirement. (g) Organic mulch materials made from recycled or postconsumer shall take precedence over inorganic materials or virgin forest products unless the recycled post-consume



TOTAL IRRIGATED LANDSCAPE AREA = 1,150 SQUARE FEET.

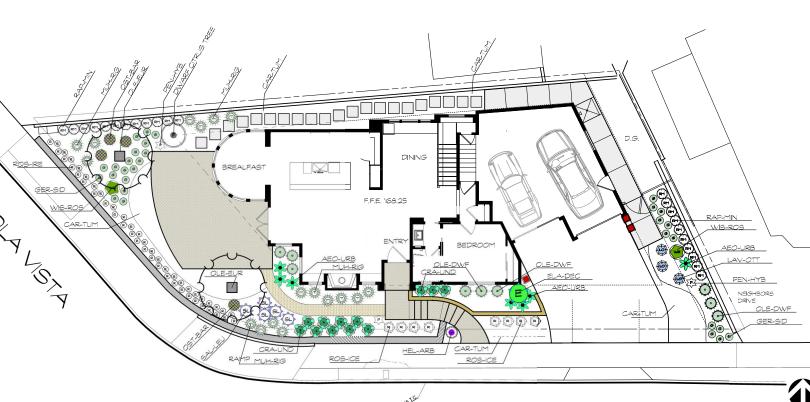

NORTH SCALE: 1/8" = 1-0" SHEET NO.

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JRAL PLANS I I SHEEHAN MENTE, CA 92672

SCAPE ARCHITECTUR SHANA AND BRIAN S 7.5. OLA VISTA · SAN CLEME PH. (949) 350-220

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DATE: 7-27-20 DRAWN BY: D.P.

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